Project Location Juniper Park

11/01/2018

by Jim Holder in Member District ADA Project Request

id. 11510399

ADAProjects@palatineparks.org

#### **Original submission**

11/01/2018

•	
Name	Ed Tynczuk
Job Title	Superintendent of Parks
E-mail Address	adaprojects@palatineparks.org
Phone Number	847-705-5140
Park District	Palatine
Project Status	New
Project Type	Routes and Surfaces
Routes and Surfaces- select a Project Category below:	Accessible Routes- Means of Egress
Benefits of the Project	Allows individuals with mobility issues to access the baseball field shelter and playground from the parking area.
Items that will become ADA Compliant	Pathway into the park
The project is designed or constructed, or applies human resources, to comply with:	The 2010 Standards for Accessible Design The Illinois Accessibility Code Agency's ADA Transition Plan

Upload Project Related Files, Photos, Videos or Audio

5241b\_Palatine\_Trail\_Juniper\_Park\_Eng\_Plans\_07-05-18\_1.pdf

20181024\_080436.jpg

20181024\_080427.jpg

20181024\_080420.jpg

20181024\_080336.jpg

20181024\_080236.jpg 20181024\_080233.jpg 20181024\_080207.jpg 20181024\_080203.jpg JuniperADACostsbid.pdf

Budget Table for ADA Related Expenses


#### a397ca9d-7186-4114-8a15-eb9bd94dcefc.xlsx


ADA Dollars Requested	27426.80
Notes related to requested amount	Costs related to the ADA portion of the project are highlighted on the bid sheet.

# PROPOSED SITE IMPROVEMENTS PALATINE TRAIL & JUNIPER PARK

## PALATINE PARK DISTRICT PALATINE, ILLINOIS


### STANDARD SYMBOLS

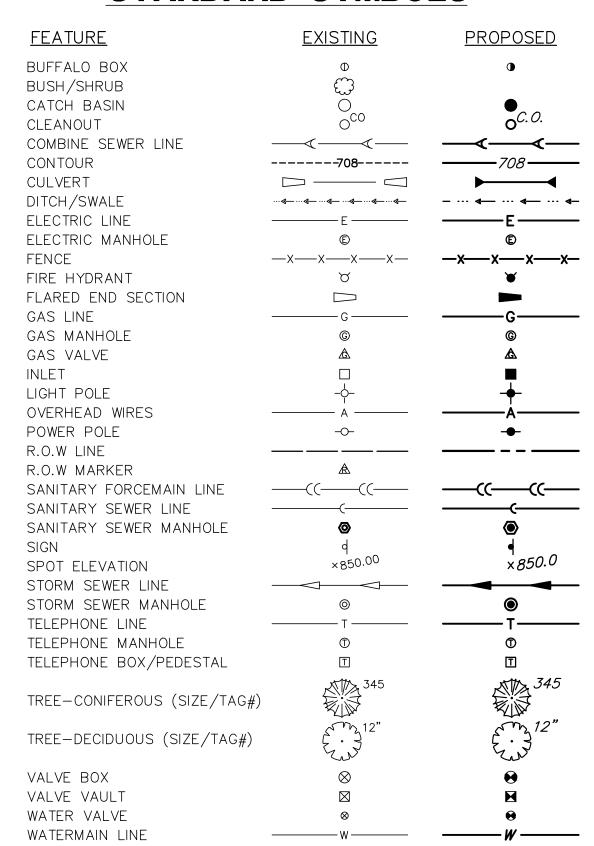

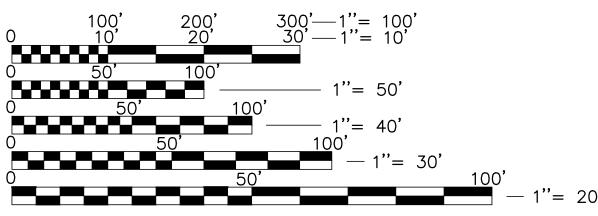

FULL SIZE PLANS HAVE BEEN PREPARED USING STANDARD ENGINEERING SCALES. REDUCED SIZED PLANS WILL NOT CONFORM TO STANDARD SCALES. IN MAKING MEASUREMENTS ON REDUCED PLANS, THE ABOVE SCALES MAY BE USED.

NOTE: CONSTRUCTION MEANS, METHODS AND JOB SITE SAFETY IS THE SOLE AND EXCLUSIVE RESPONSIBILITY OF THE CONTRACTOR

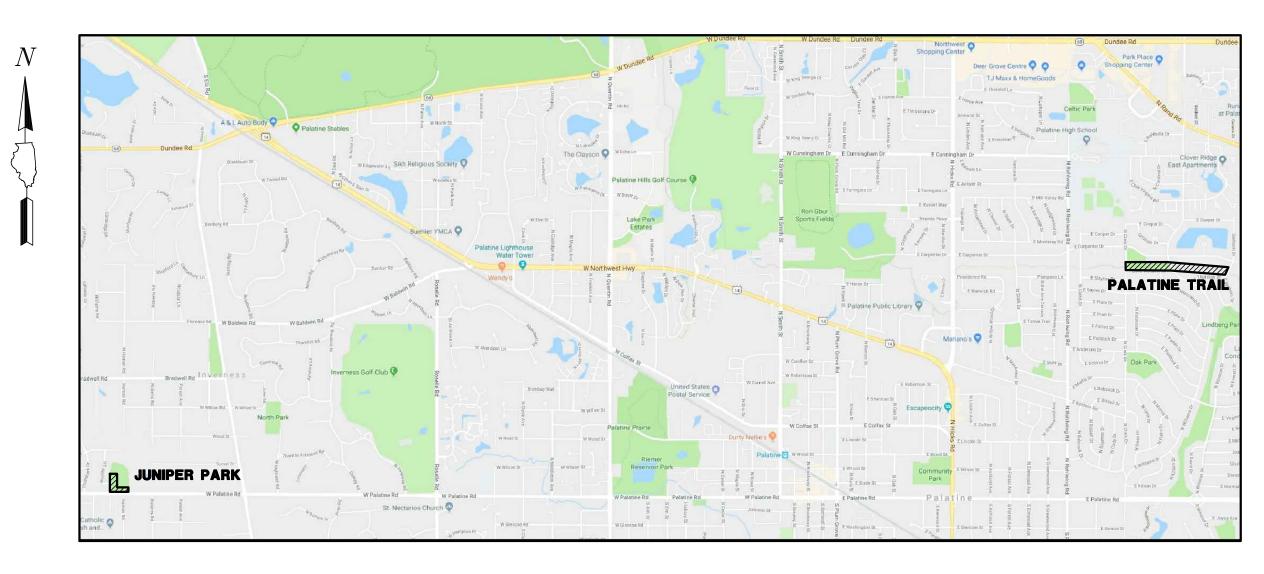

## **LOCATION MAP**

PALATINE TRAIL NORTH CLARK DRIVE TO EAST SANBORN DRIVE PALATINE, ILLINOIS 60074

Know what's below.

Call before you dig.

JUNIPER PARK 1000 WEST PALATINE ROAD HOFFMAN ESTATES, ILLINOIS 60195

### (Not to Scale)

BENCHMARK:

ELEVATIONS SHOWN HEREON ARE OBTAINED VIA GPS USING TRIMBLE VRS®NOW™ (NO PUBLISHED MONUMENT VERIFIED)

#### **TOPOGRAPHIC SURVEY BY:** GEWALT HAMILTON ASSOCIATES, INC. 625 FOREST EDGE DRIVE

TELEPHONE: 847-478-9700

PLANS PREPARED FOR PALATINE PARK DISTRICT 250 EAST WOOD STREET

TELEPHONE: 847-991-0333

PALATINE, ILLINOIS 60067

## VERNON HILLS, ILLINOIS 60061

#### SHEET INDEX

- 1. TITLE SHEET
- 2. PALATINE TRAIL PROPOSED PATH LAYOUT
- 3. PALATINE TRAIL PROPOSED IMPROVEMENTS STA. 0+00 TO 9+50
- 4. PALATINE TRAIL PROPOSED IMPROVEMENTS STA. 9+50 TO 13+00
- 5. PALATINE TRAIL PROPOSED IMPROVEMENTS STA. 13+00 TO 23+80
- JUNIPER PARK EXISTING CONDITIONS/DEMOLITION PLAN JUNIPER PARK - PROPOSED IMPROVEMENTS
- JUNIPER PARK PROPOSED GRADING CLOSE-UP
- 9. SOIL EROSION AND SEDIMENT CONTROL DETAILS
- 10. MWRD GENERAL NOTES
- 11. GENERAL NOTES AND DETAILS

#### COORDINATING/PERMITTING AGENCIES.

**PALATINE TRAIL PROJECT** 

VILLAGE OF PALATINE 200 EAST WOOD STREET PALATINE, ILLINOIS 60067 TELEPHONE: 847-202-6963

METROPOLITAN WATER RECLAMATION DISTRICT OF GREATER CHICAGO (MWRDGC) 111 EAST ERIE STREET CHICAGO, ILLINOIS 60611 TELEPHONE: 312-751-5600

#### JUNIPER PARK PROJECT

VILLAGE OF HOFFMAN ESTATES 1900 HASSELL ROAD HOFFMAN ESTATES, ILLINOIS 60169 TELEPHONE: 847-882-9100

S	SIGNED:	TOM RYCHLIK		<u>P.E.</u>
D	ATE:			
IL	LINOIS LICEN	ISE NO.: 062-05	56334	
Ε	XPIRATION D	ATE: NOVEMBER	30, 2019	

ASSOCIATES, INC.

625 Forest Edge Drive Vernon Hills, IL. 60061

TEL 847.478.9700 FAX 847.478.9701

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J.U.L.I.E

**INFORMATION FOR** 


**EXCAVATION** 

**CALL 811** 

JOINT UTILITY LOCATION

> TITLE SHEET PROPOSED SITE IMPROVEMENTS PALATINE PARK DISTRICT PALATINE, ILLINOIS

	FILE: 5241.210 — DT1 Pala	tine Trail & Juniper Park.dwg	SHEET NUMBER:
	<b>DRAWN BY:</b> EJS <b>DATE:</b> 07-05-18	GHA PROJECT #	1
NO. BY DATE REVISION	<b>CHECKED BY:</b> TAR <b>DATE:</b> 07-05-18		OF 11 SHEETS

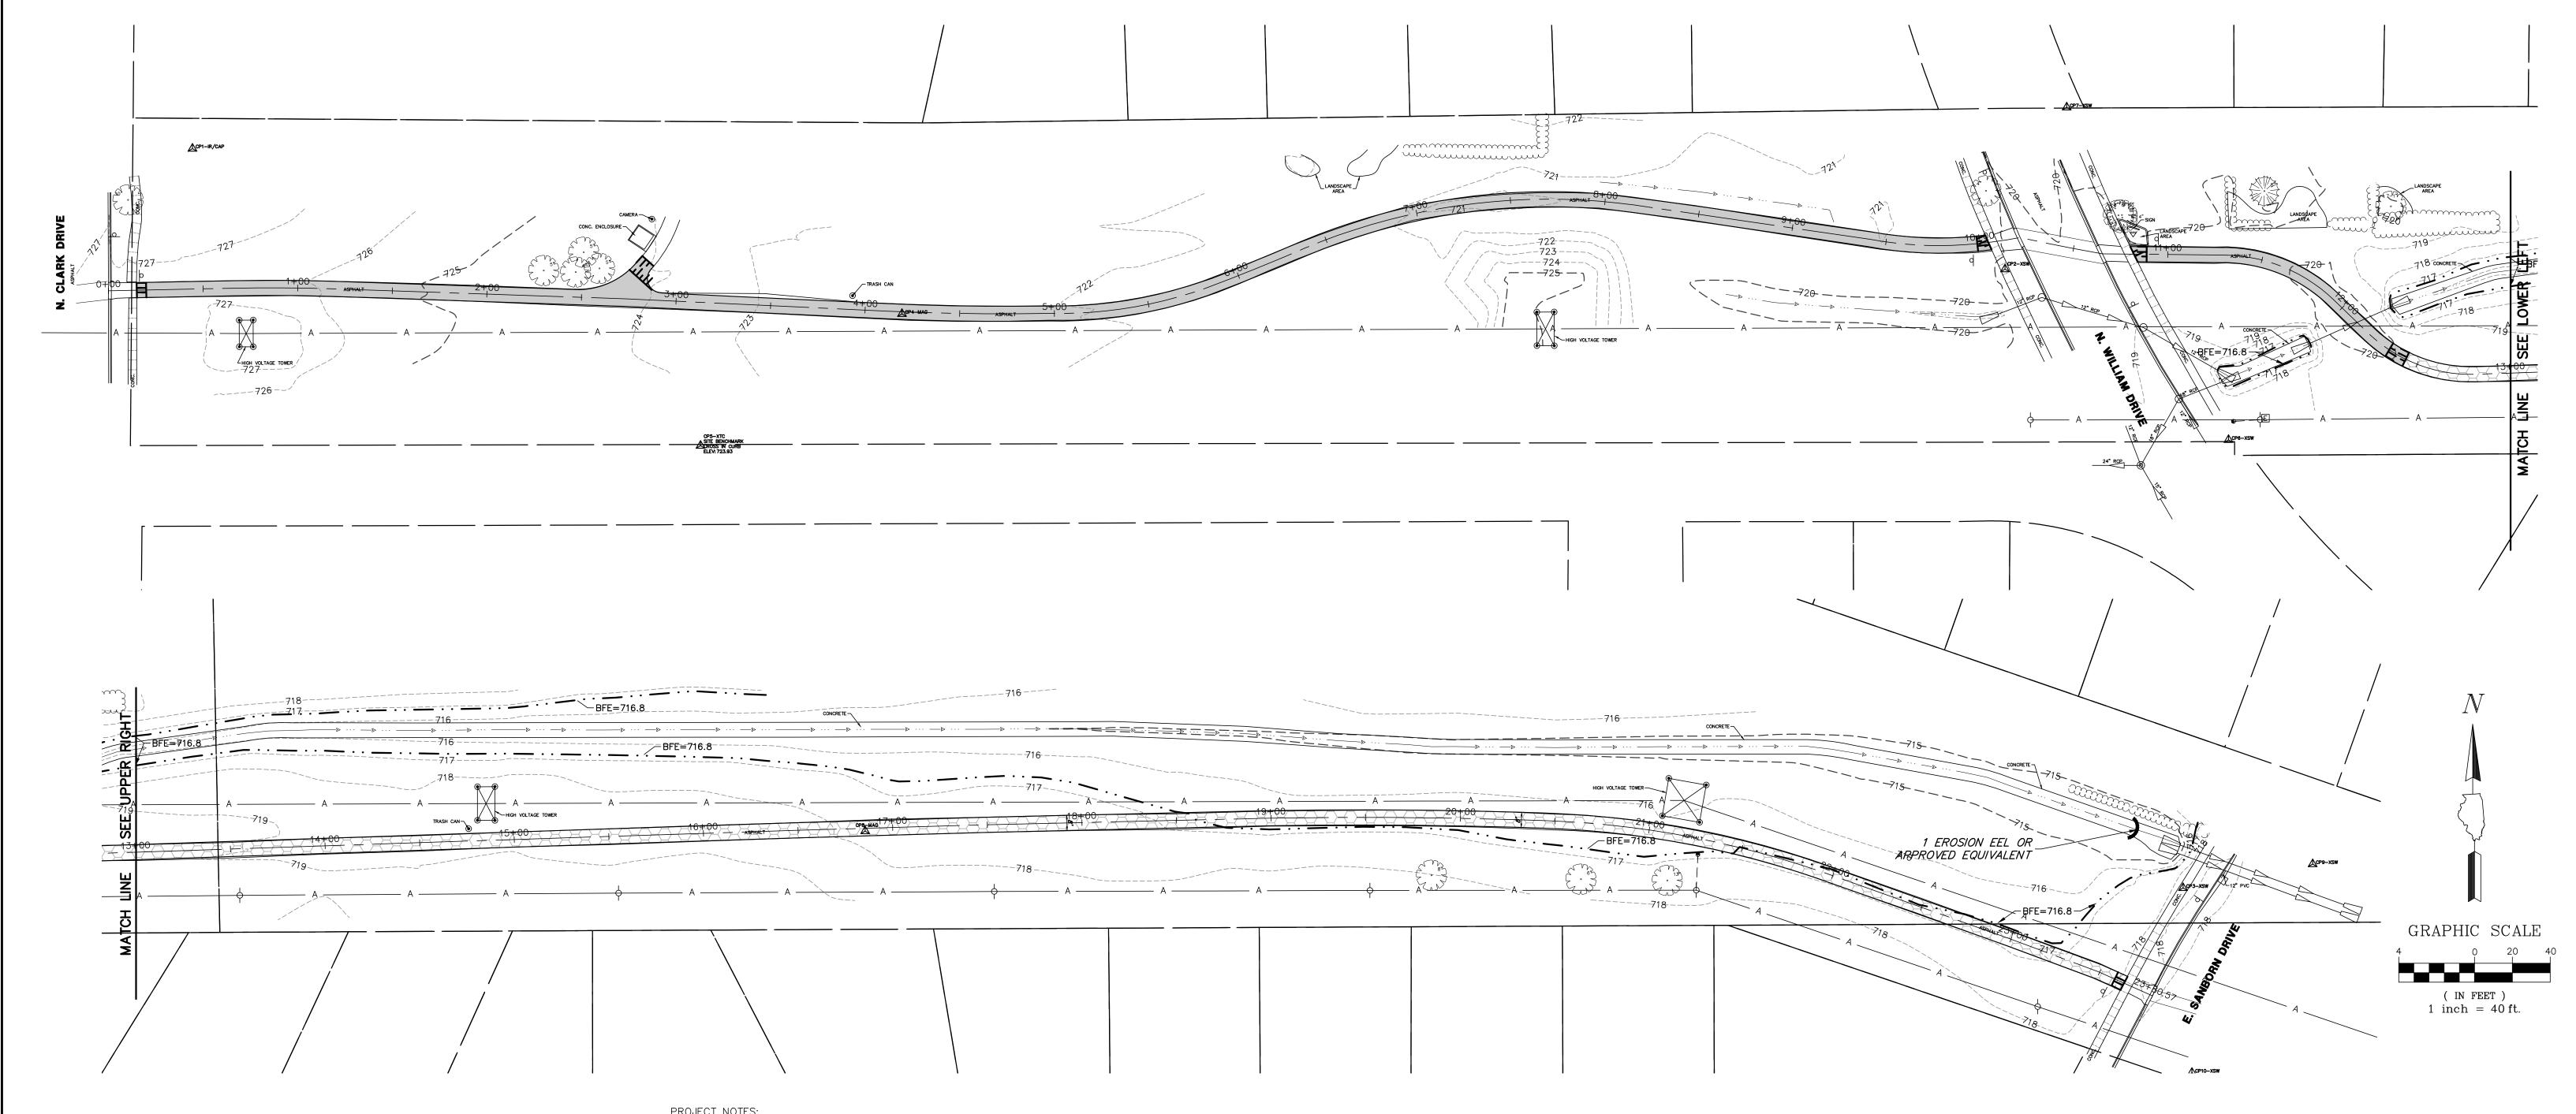

### PROPOSED LEGEND



BITUMINOUS PAVEMENT OVERLAY 2" (MINIMUM) HMA SURFACE COURSE MIX D, N50



BITUMINOUS SURFACE REMOVAL (2.5" AVERAGE), STONE COMPACTION & PLACEMENT OF 2.5" HMA SURFACE COURSE MIX D, N50

\_\_\_\_\_\_\_ HMA SURFACE REMOVAL — BUTT JOINT

#### PROJECT NOTES:

- 1. Prior to starting any construction, provide soil erosion and sediment control devices as shown on the plans. Refer to notes and details throughout the entire plan set
- 2. No fill shall be placed within the floodplain boundary.
- 3. N. Clark Drive, N. William Drive, and E. Sanborn Drive are under the jurisdiction of the Village of Palatine. All work within the right of way will require a permit.
- 4. The contractor shall be responsible for fencing the active work zone from the public and protecting the public from any construction related hazards. At a minimum, all excavation, demolition areas and other areas potentially hazardous to pedestrians and vehicles must be protected.
- 5. The contractor shall import or export soil as necessary to construct the site to specified plan grades. Such work is considered incidental to the contract and no additional compensation shall be allowed for such work. Minor adjustments to grades can be accommodated with Project Engineer approval.
- 6. The Contractor shall include all associated costs with the removal, transport, disposal, testing and certification of "Uncontaminated Soil" as defined under 415 ILCS 5/3.160 including any fees, taxes, or surcharges charged by or through the operator(s) of Clean Construction or Demolition Debris Fill Operations or Uncontaminated Soil Fill Operations for the acceptance of Uncontaminated Soil.
- 7. The contractor is responsible for the demolition and disposal of all existing improvements onsite necessary to complete the job. These improvements include, but are not limited to, existing pavements, curbs, sidewalks, utilities, lighting, light bases, manholes, fences, foundations, and other structures within the work area. Excavate and grade to proposed pavement. These items shall be completely removed and legally disposed of offsite.
- 8. Temporary stone or asphalt pathways shall be provided as needed throughout the course of construction to facilitate safe pedestrian and vehicular movement. The longitudinal slope of such paths shall not exceed 5% and cross slopes shall not exceed 2%. Provide 6" CA-6 base and 2" surface asphalt.
- 9. Refer to General Notes for grading, compaction and proof roll requirements.
- 10. All pavement dimensions are to edge of pavement, unless otherwise noted. E=edge of pavement, B=back of curb, F=face of curb. Radii dimensions are to back of curb.
- 11.Install bituminous pavement as shown. Refer to detail sheet for specific pavement sections and general note sheet for construction, testing and compaction requirements.

- 12. Provide 1.9% cross slope and 4.5% maximum longitudinal slope on all sidewalks and pedestrian pathways unless otherwise indicated. Illinois accessibility code requires a mazimium constructed cross slope and 2.00% and longitudinal slope of 5.00%.
- 13. The contractor shall minimize disturbed areas duration construction and restore all disturbed turf areas with 14. Contractor shall install temporary erosion control seed and blanket as necessary to meet soil erosion and
- sediment control requirements. Refer to notes and details throughout the plan set for specific material 15. For final restoration, the contractor shall be responsible for restoring all disturbed turf areas and proposed turf
- a. Prior to placement of topsoil restoration area subgrade material shall be rototilled and re-compacted to a
- maximum of 80% standard proctor to a depth of 6. b. Spread a minimum of 4 (Lawn Area) or 8" (Native Area) of existing site salvaged screened topsoil or new
- pulverized topsoil on all disturbed areas. Compact to 80% standard proctor. c. Topsoil must be free of litter, brush, rocks and earth clods of greater than 1 inch in any dimension. Contain between 1%—10% organic matter, 12%—50% clay, and less than 55% sand content. pH shall be between 6.0 and
- d. Seed restoration areas as follows:
- IDOT Class 1a seed. (Lawn mixture) • IDOT Class 4 seed. (Native Grass)
- Fertilizer shall be applied following IDOT requirements.
- Erosion control blanket shall be North American Green S75 or approved equal installed following manufacturer f. Contractor shall be responsible for watering the restored area per IDOT specifications for a duration of 30 days prior to the Owner's final review and acceptance. If restoration has not shown a catch or uniform stand, the
- 16. Once restoration has been completed, the contractor shall remove erosion control devices. Silt fence trenches shall be backfilled and restored in kind. Storm structures shall be cleaned of debris.
- 17. Contractor shall provide the following as—constructed documents at the conclusion of the project:

contractor shall repeat reseeding or resodding until a uniform stand is achieved.

- a. ADA sidewalk ramps & landings. • Provide 4 spot grades per square at landings and any tampers or ramps.
- Provide spot elevations along route at maximum 10 foot spacing on both sides of the path to confirm cross and longitudinal slopes requirements have been met.

BENCHMARK: ELEVATIONS SHOWN HEREON ARE OBTAINED VIA GPS USING TRIMBLE VRS®NOW™ (NO PUBLISHED MONUMENT VERIFIED) DATUM: NAVD88

#### CONTROL POINTS:

Point #	Northing	Easting	Elevation	Description
1	1988336.83	1069529.32	727.57	CP1-IR/CAP
2	1988273.09	1070486.85	719.91	CP2-XSW
3	1988199.27	1071835.30	718.12	CP3-XSW
4	1988249.50	1069904.14	722.28	CP4-MAG
5	1988179.82	1069797.71	723.93	CP5-XTC-TBM
6	1988182.88	1070604.94	718.89	CP6-XSW
7	1988358.62	1070519.43	720.35	CP7-XSW
8	1988229.28	1071139.10	717.56	CP8-MAG
9	1988211.88	1071903.78	718.65	CP9-XSW
10	1988101.64	1071840.03	718.30	CP10-XSW

GEWALT HAMILTON ASSOCIATES, INC. 625 Forest Edge Drive Vernon Hills, IL. 60061

TEL 847.478.9700 FAX 847.478.9701

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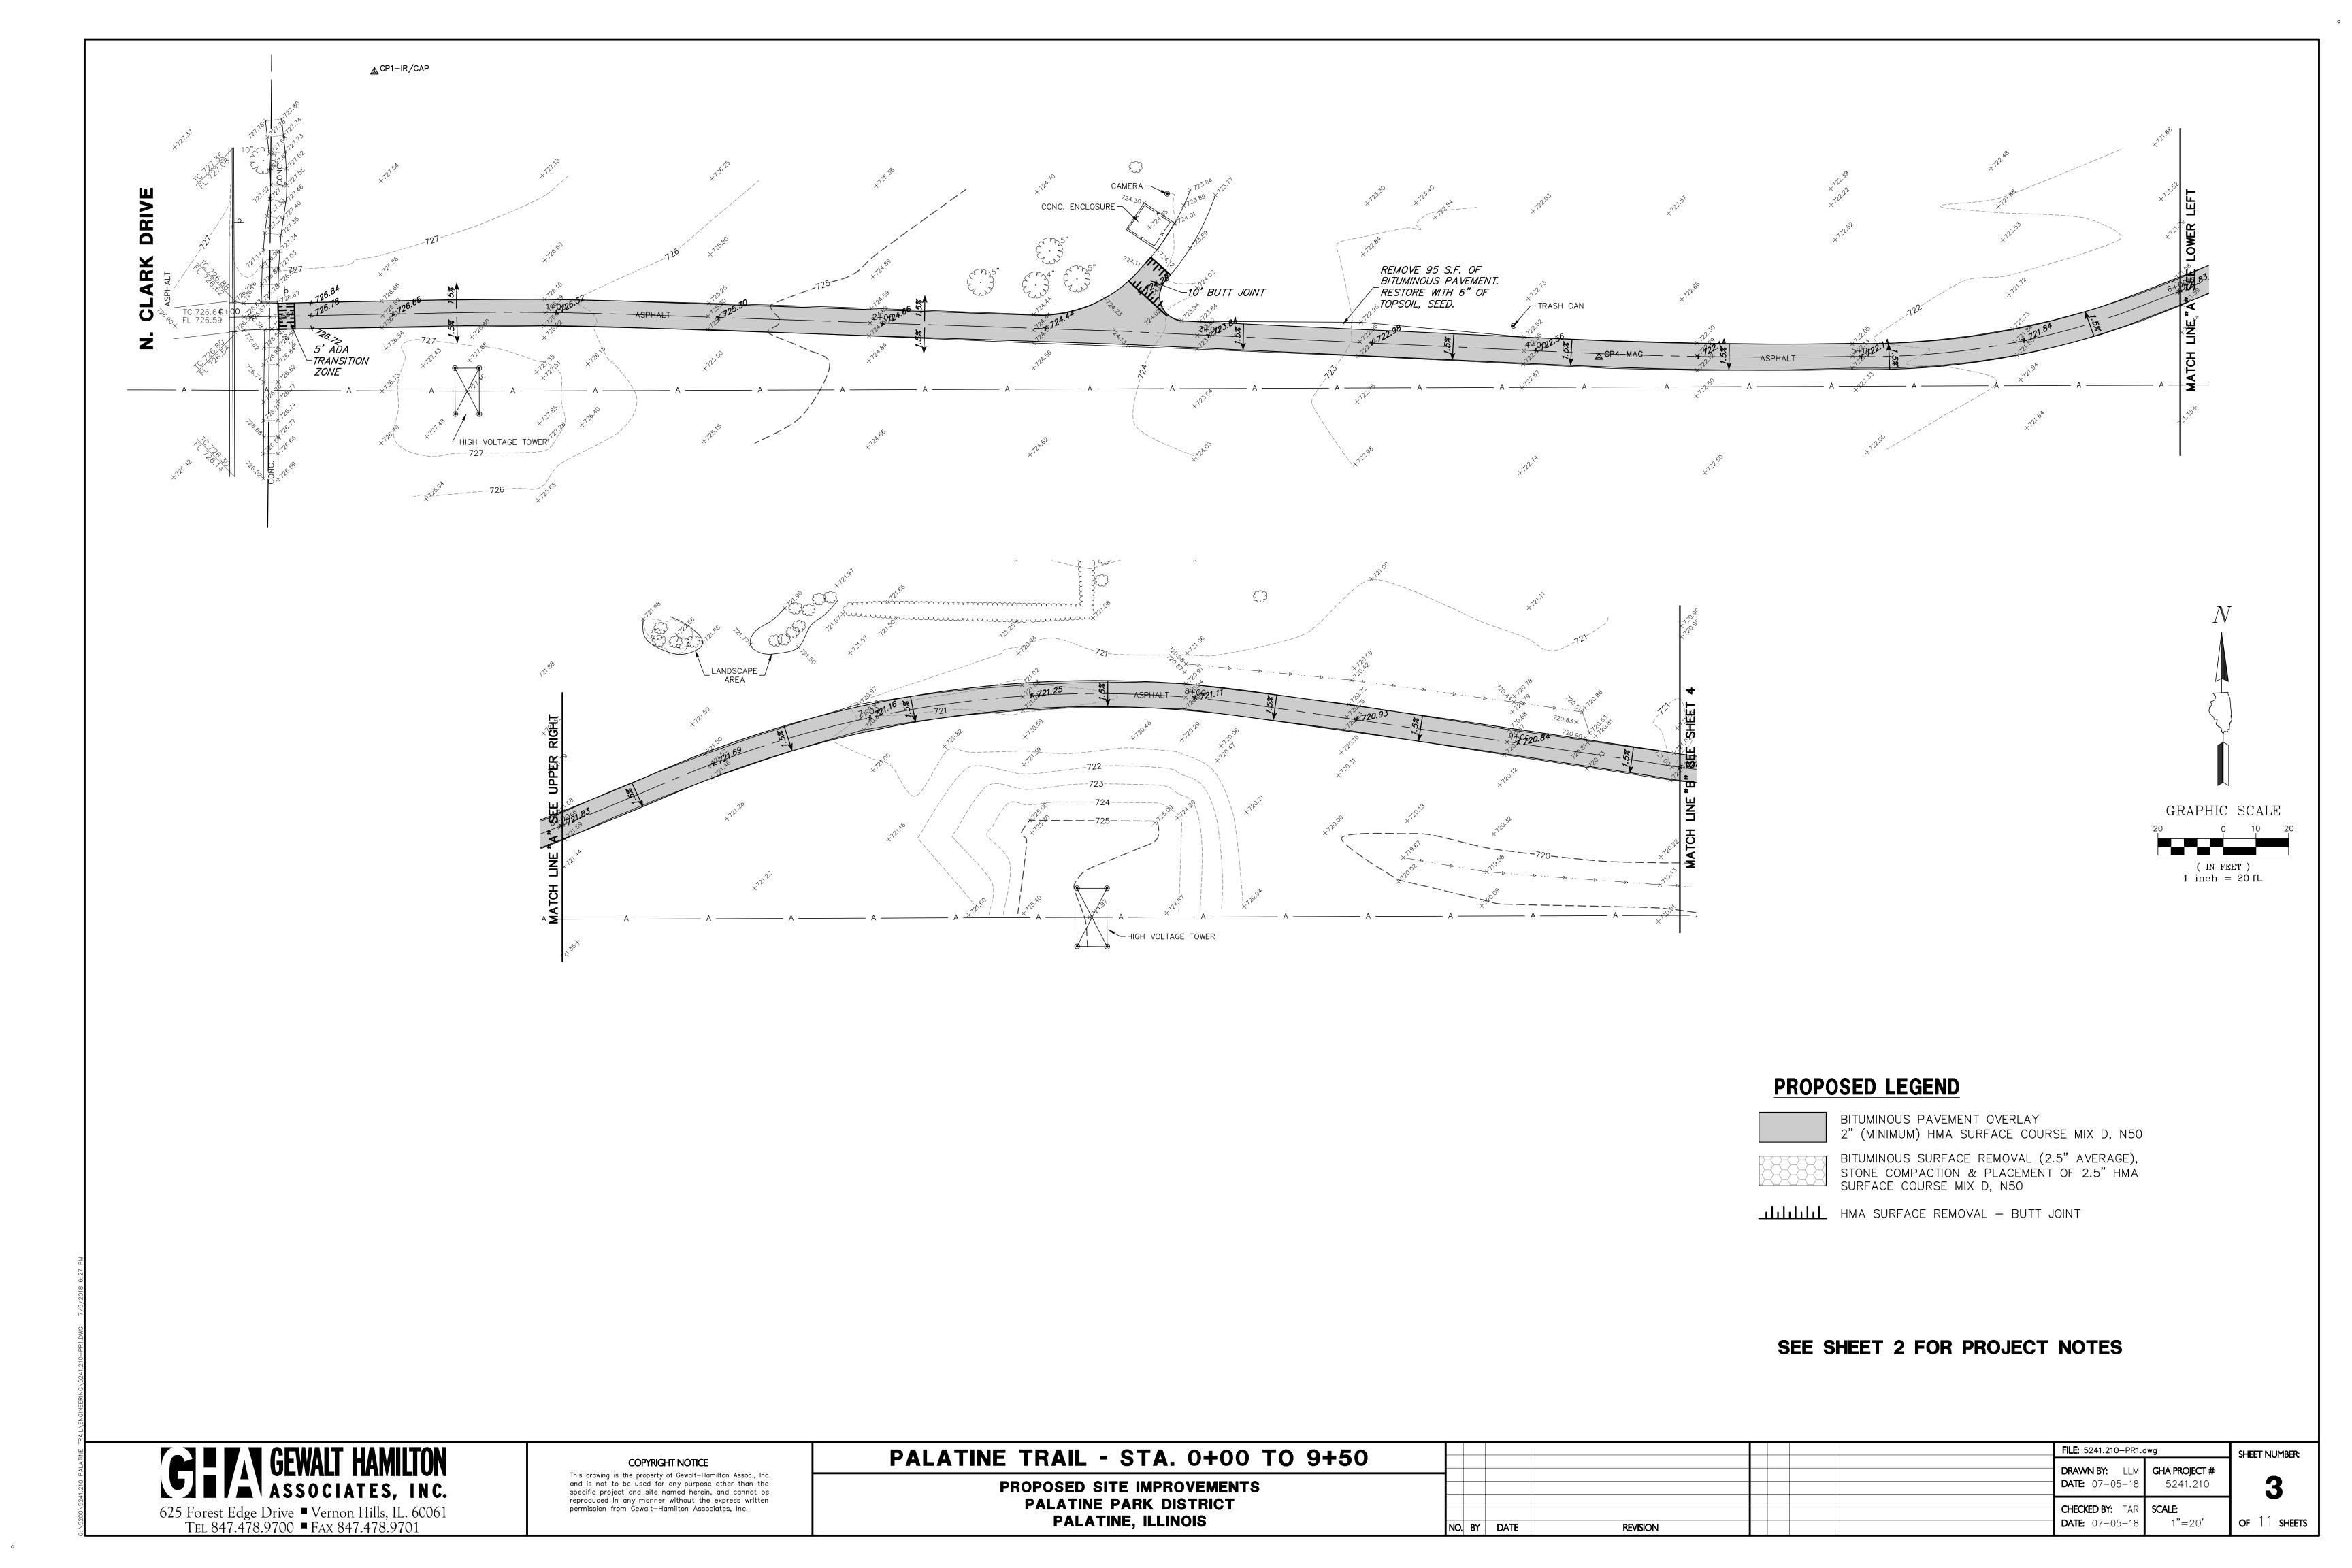
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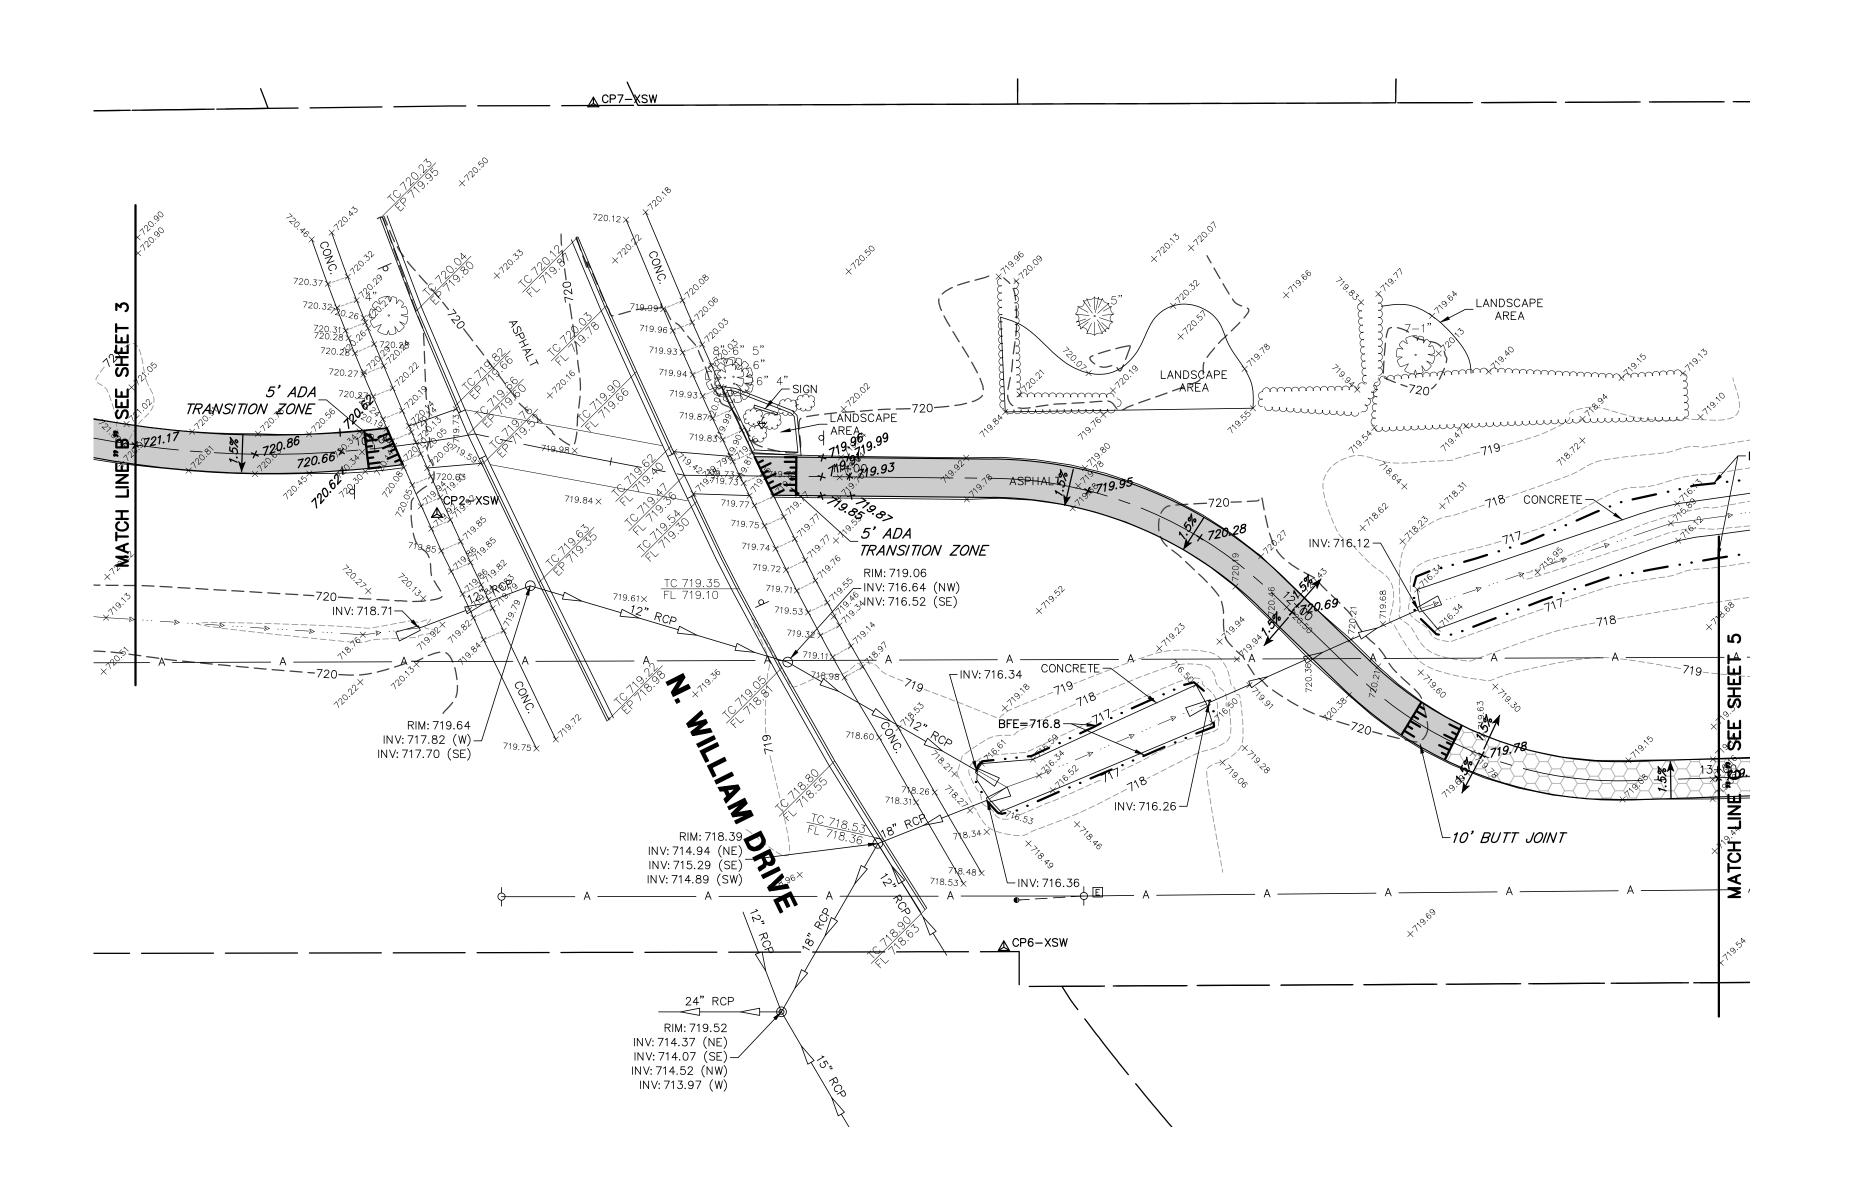
### PALATINE TRAIL - PROPOSED PATH LAYOUT


PROPOSED SITE IMPROVEMENTS PALATINE PARK DISTRICT PALATINE, ILLINOIS

					FILE: 5241.210-PR1.0	dwg
					<b>DRAWN BY:</b> LLM <b>DATE:</b> 07-05-18	<b>GHA PROJECT #</b> 5241.210
BY	DATE	REVISION			<b>CHECKED BY:</b> TAR <b>DATE:</b> 07-05-18	<b>SCALE:</b> 1"=40'

SHEET NUMBER: OF 11 SHEETS





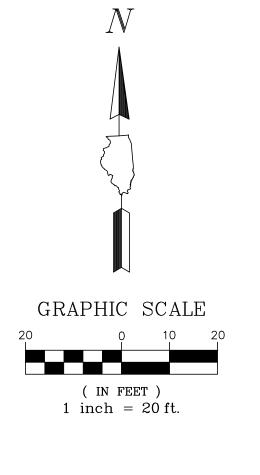

### PROPOSED LEGEND

BITUMINOUS PAVEMENT OVERLAY 2" (MINIMUM) HMA SURFACE COURSE MIX D, N50

BITUMINOUS SURFACE REMOVAL (2.5" AVERAGE), STONE COMPACTION & PLACEMENT OF 2.5" HMA SURFACE COURSE MIX D, N50

\_\_\_\_\_\_\_ HMA SURFACE REMOVAL — BUTT JOINT

SEE SHEET 2 FOR PROJECT NOTES

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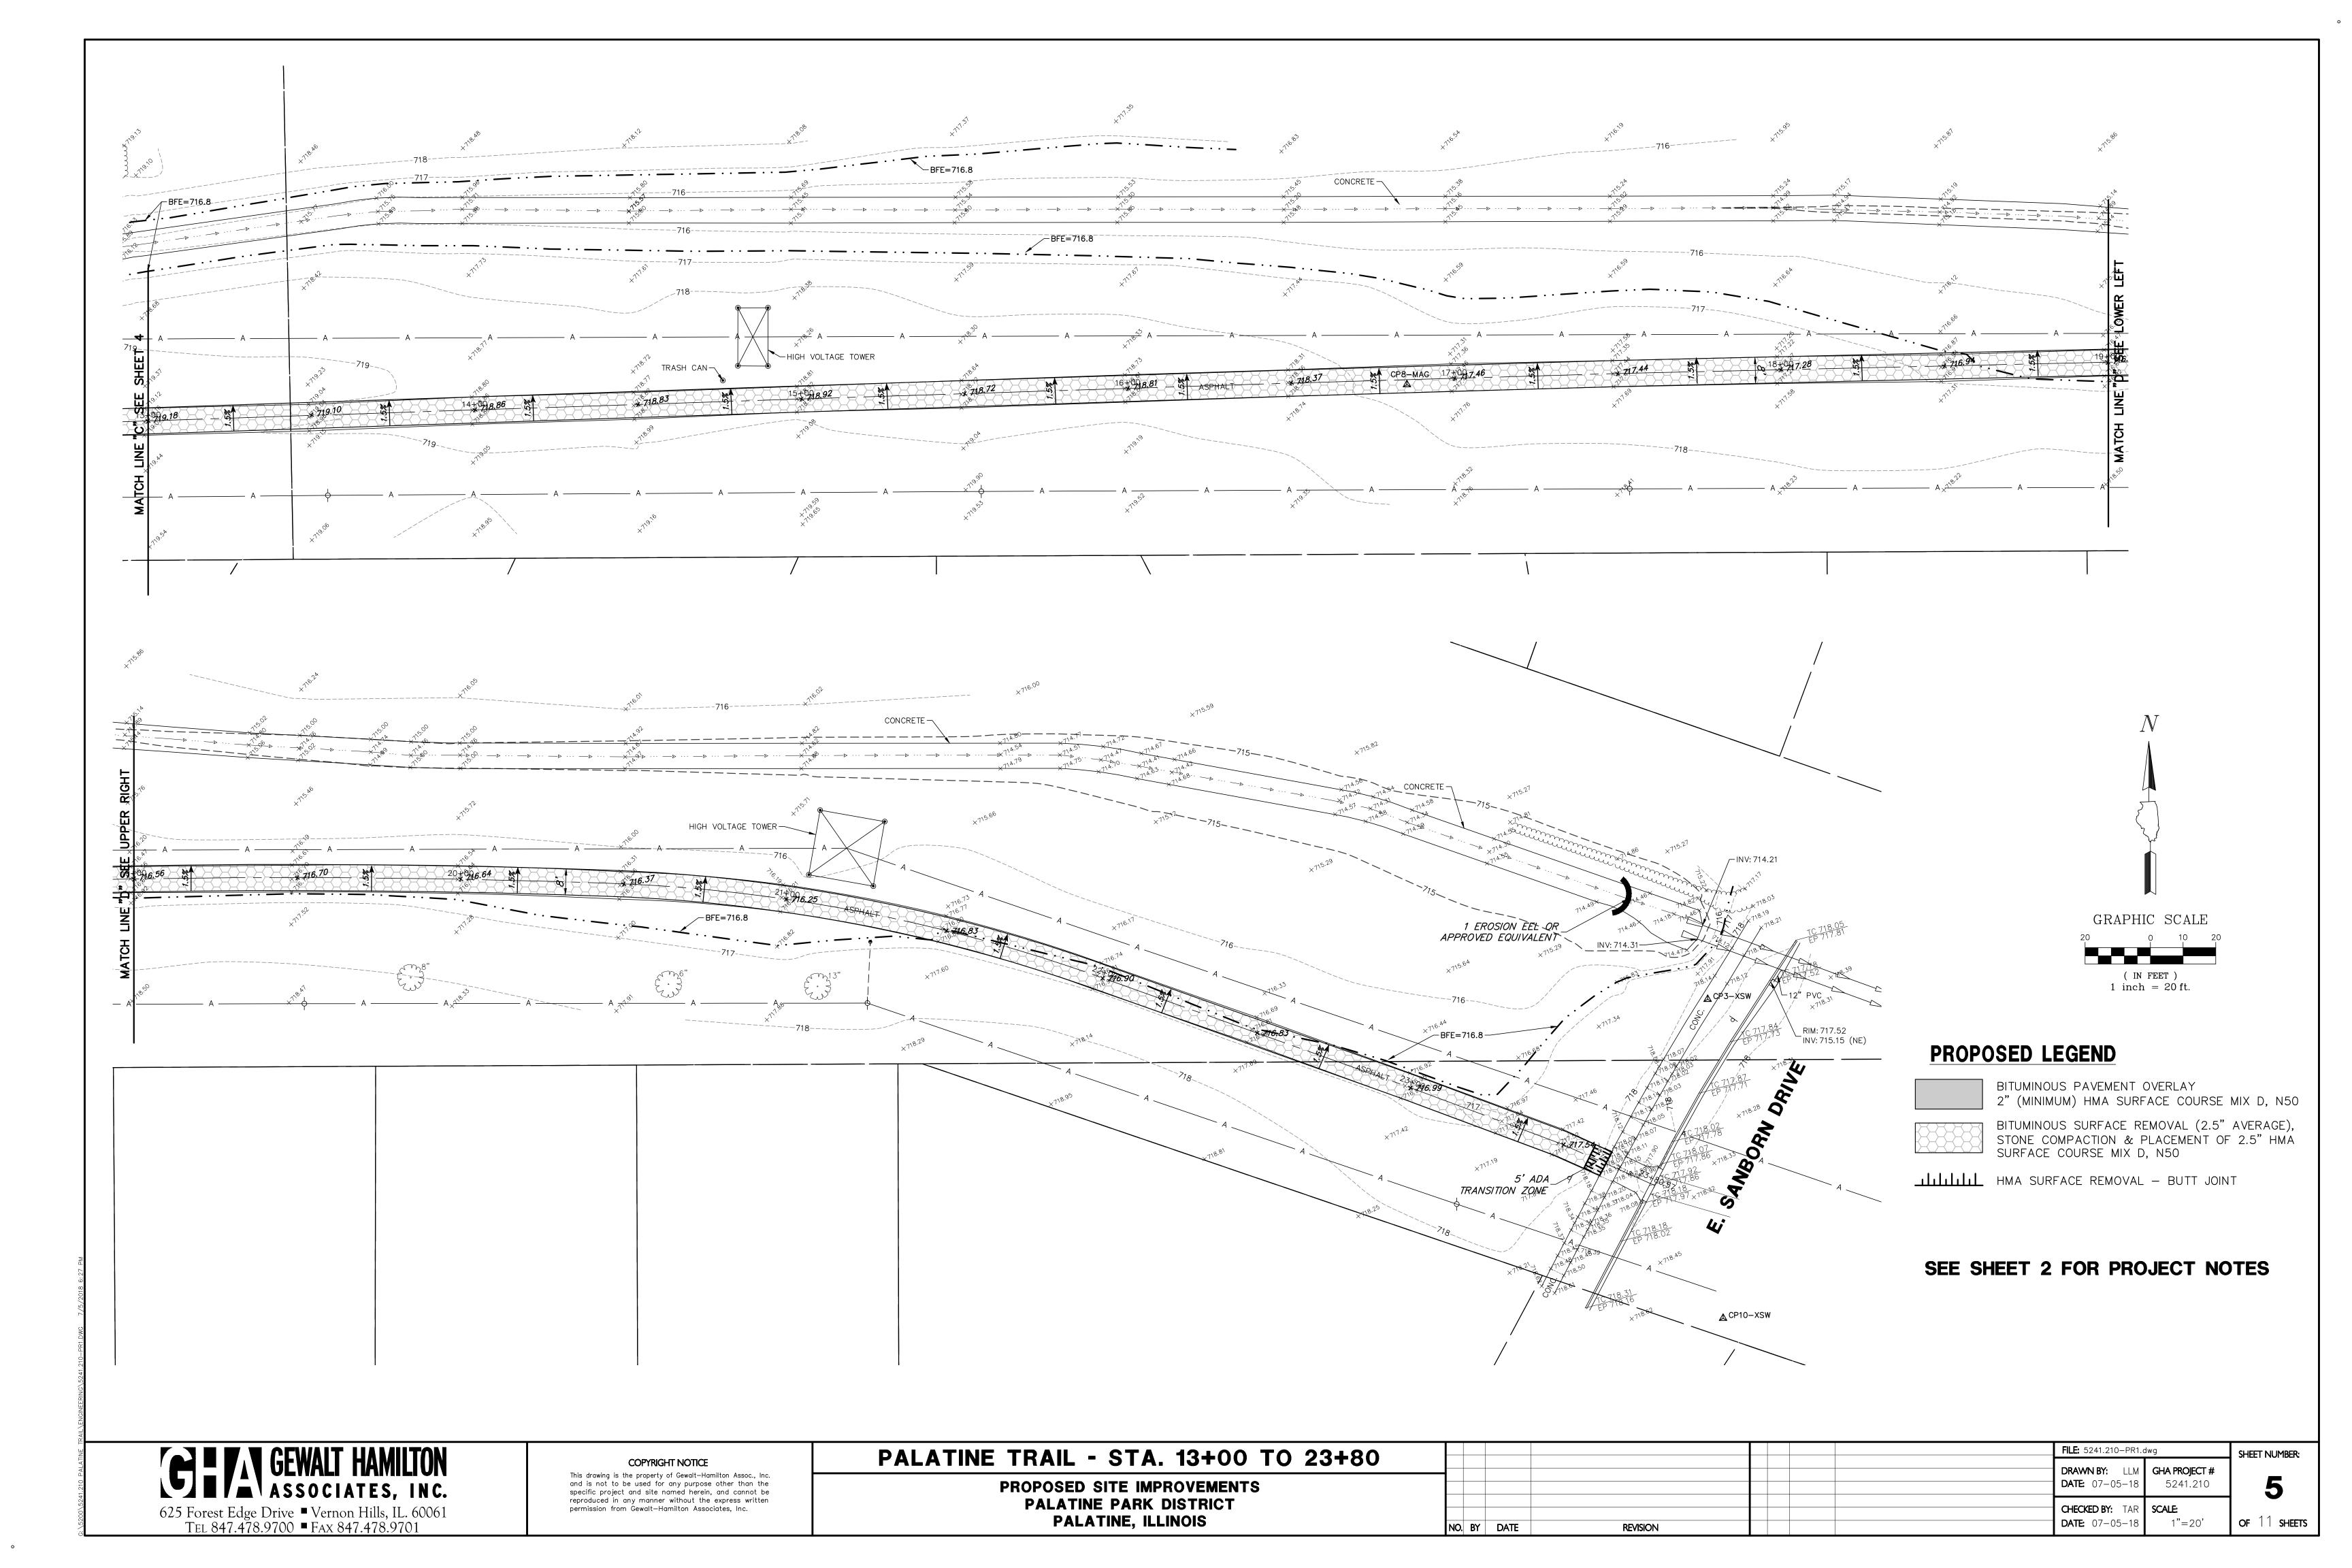
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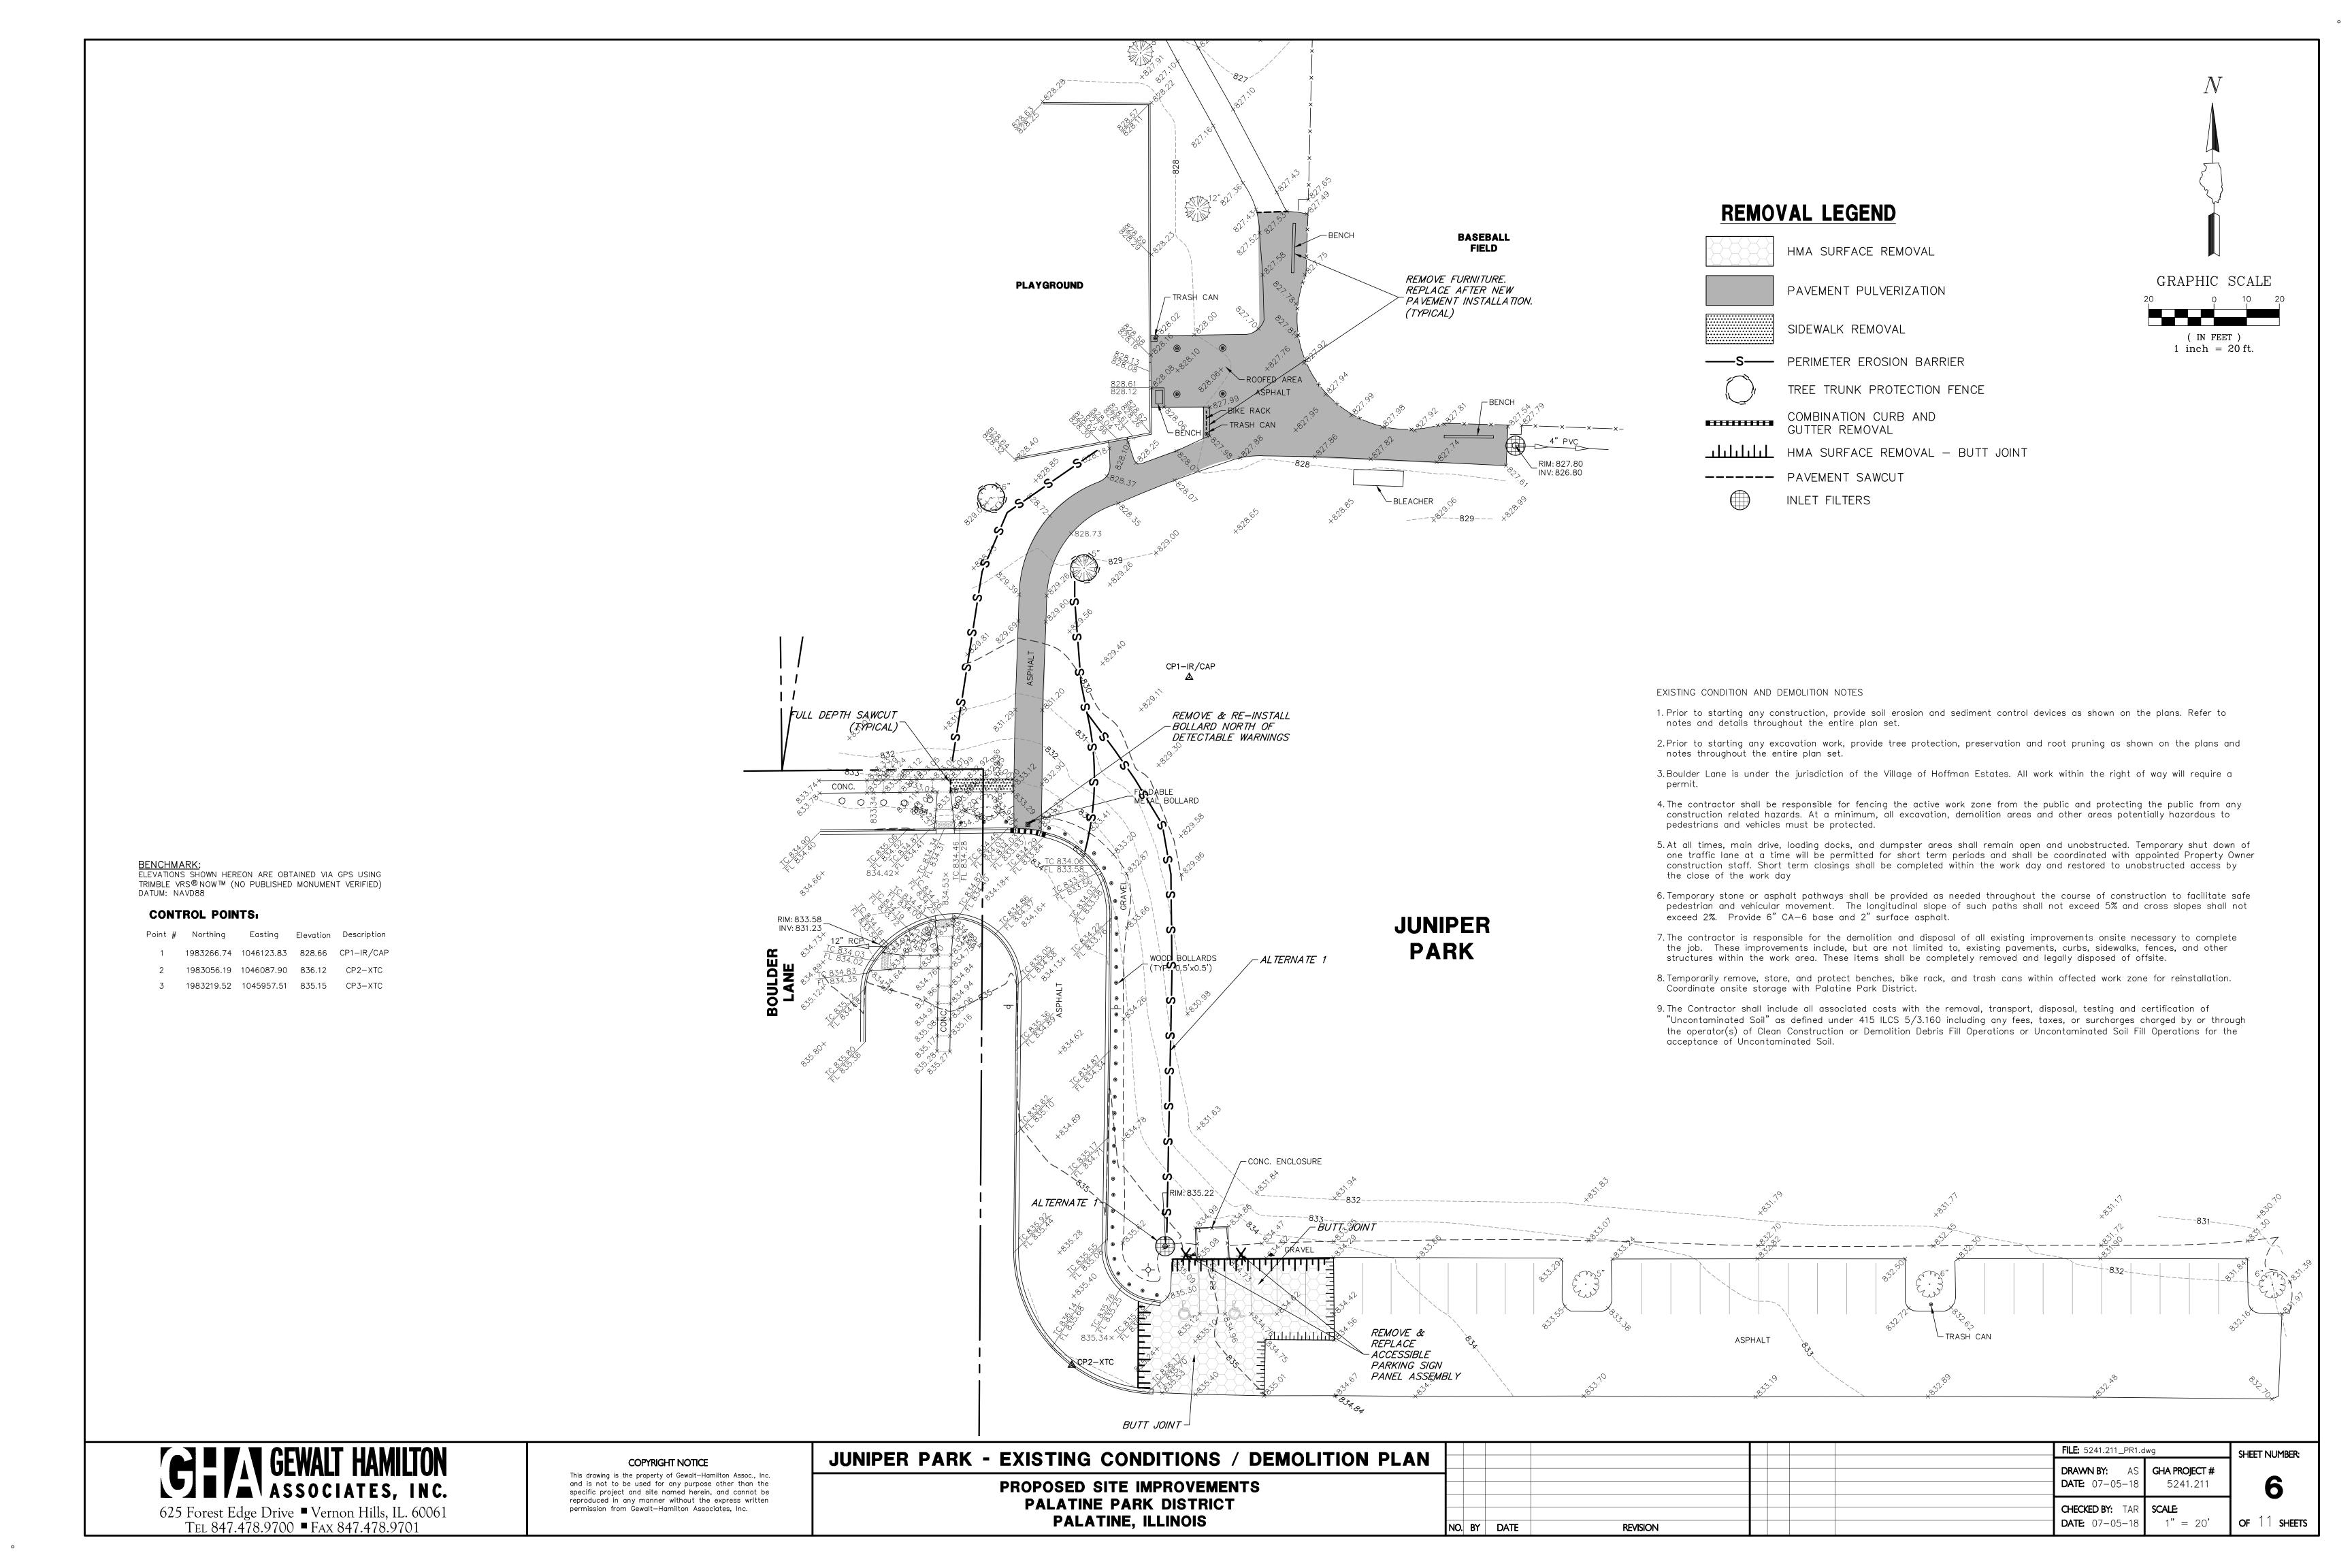
PALATINE TRAIL - STA. 9+50 TO 13+00 PROPOSED SITE IMPROVEMENTS PALATINE PARK DISTRICT


PALATINE, ILLINOIS


					<b>FILE:</b> 5241.210-PR1.0	dwg
					<b>DRAWN BY:</b> LLM <b>DATE:</b> 07–05–18	<b>GHA PROJECT #</b>
					<b>DAIL</b> 07-03-18	3241.210
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O. BY	DATE	REVISION			<b>DATE:</b> 07-05-18	1"=20'

SHEET NUMBER: OF 11 SHEETS





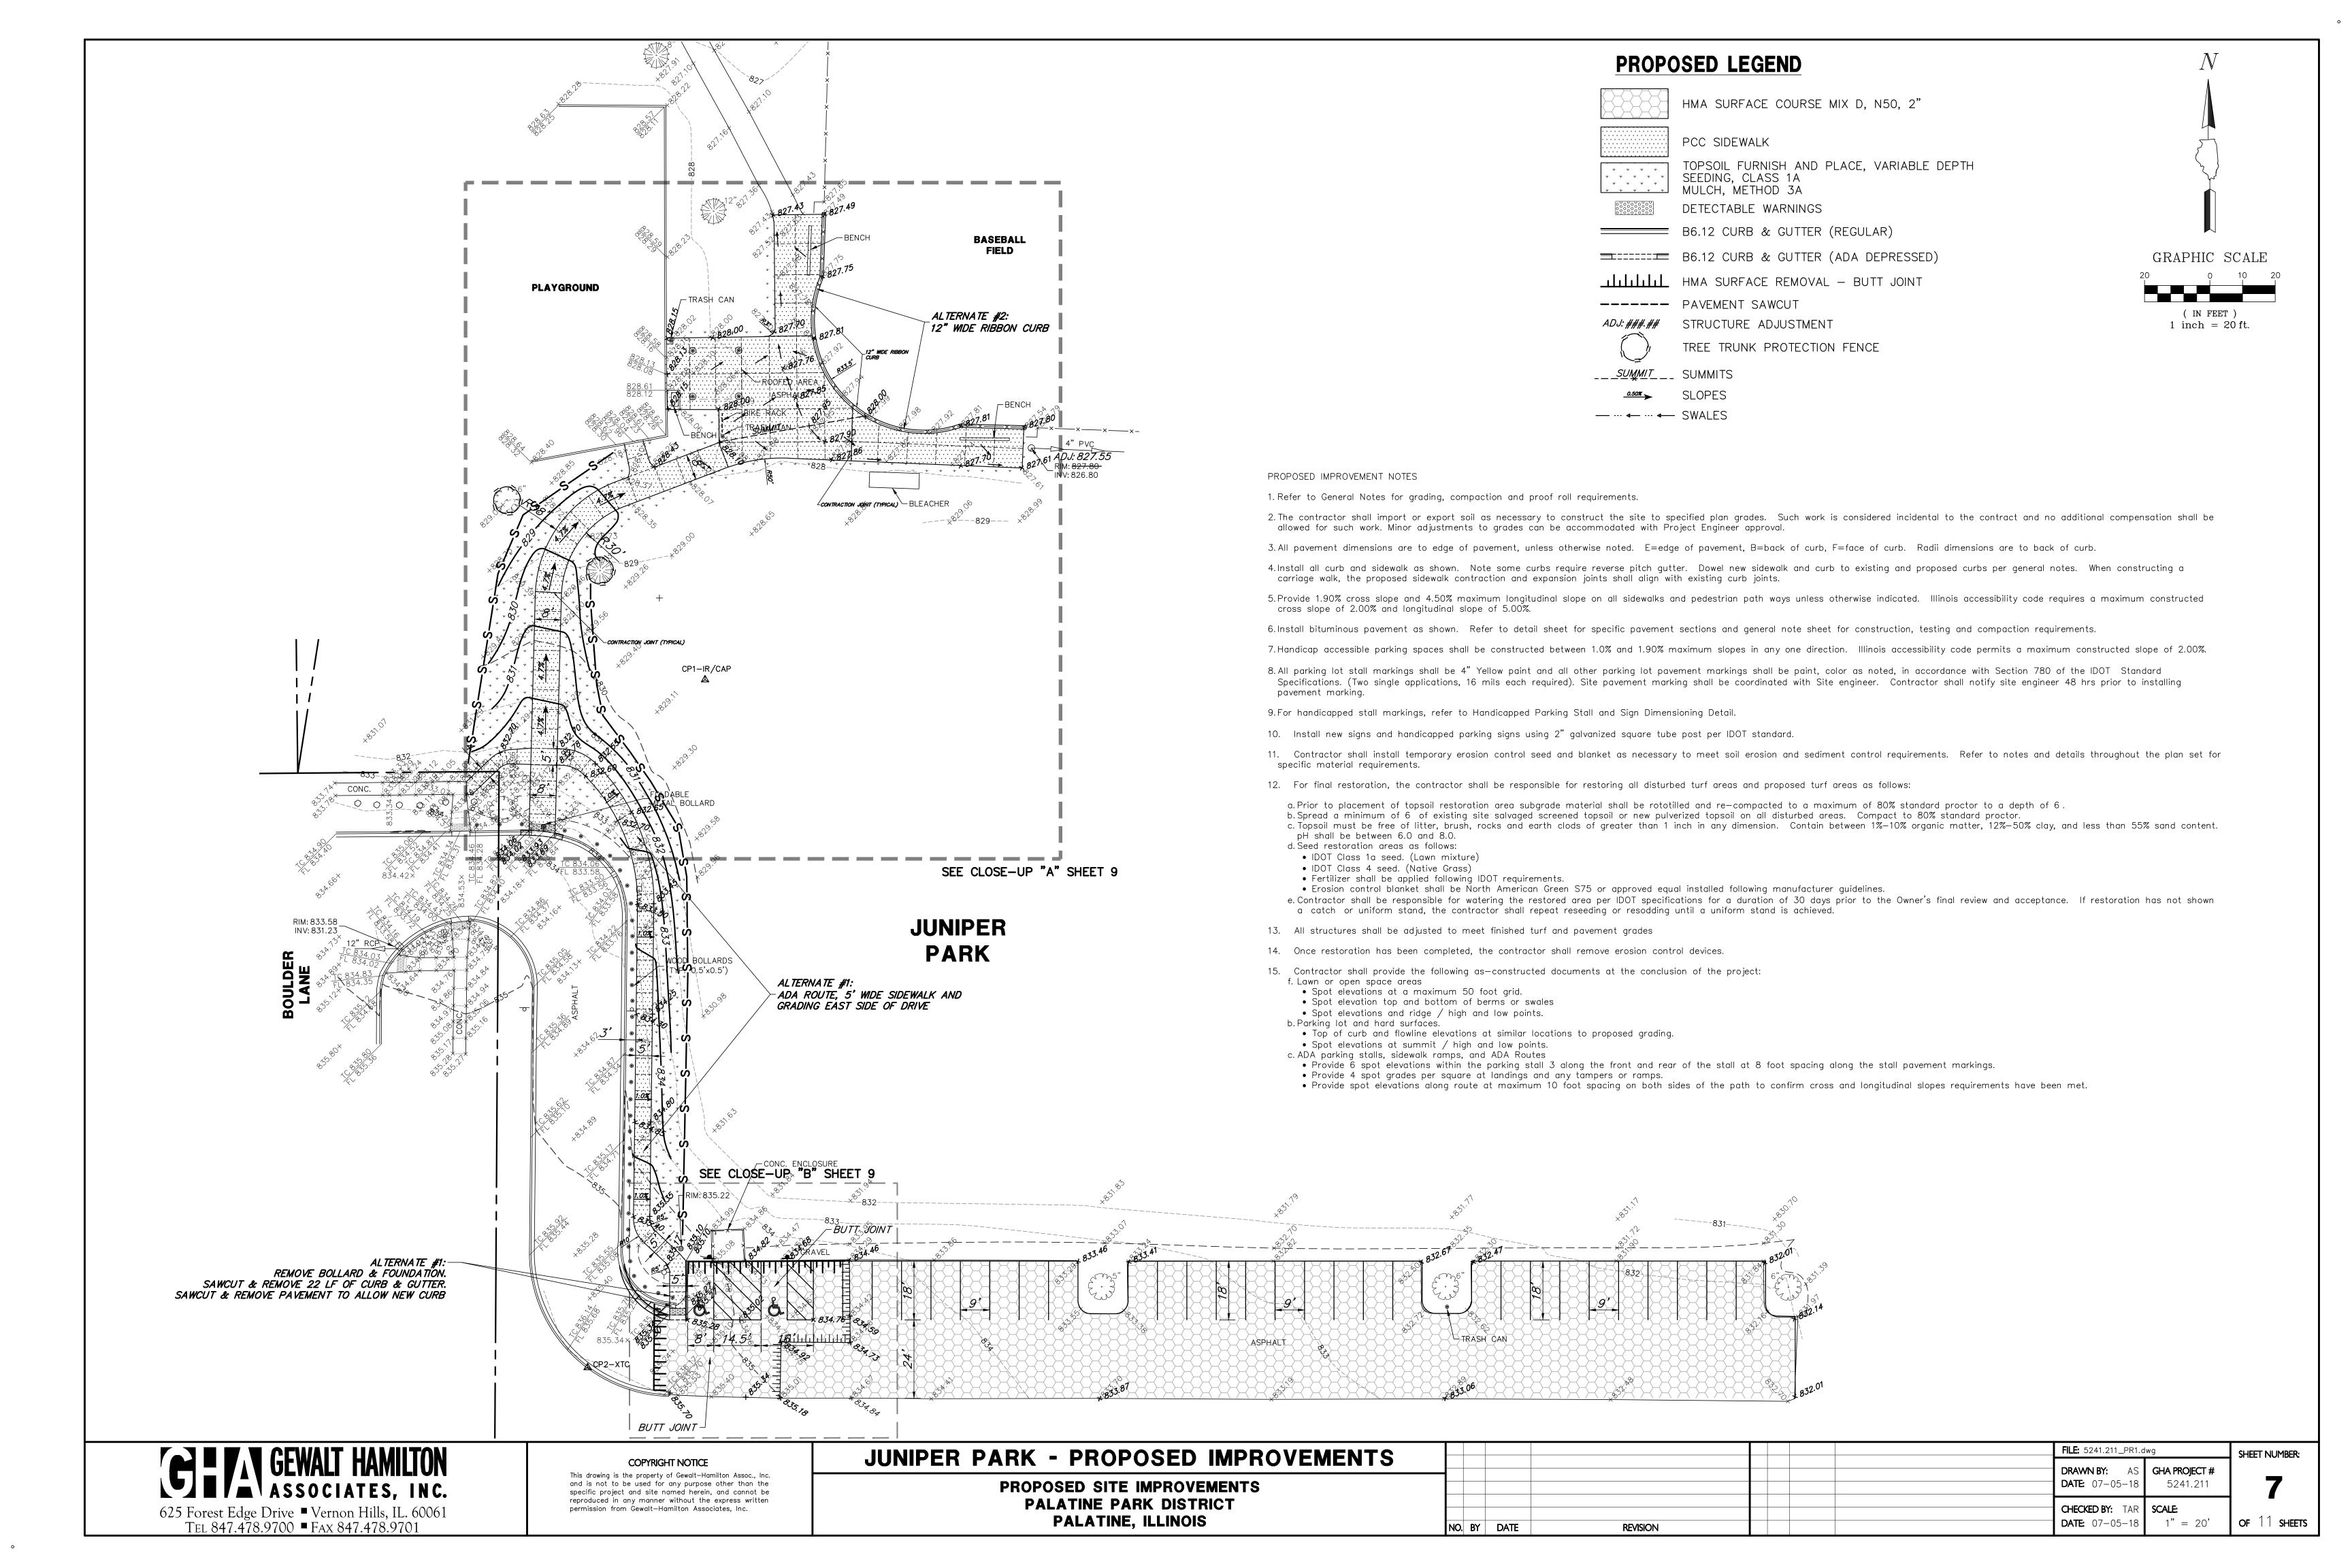

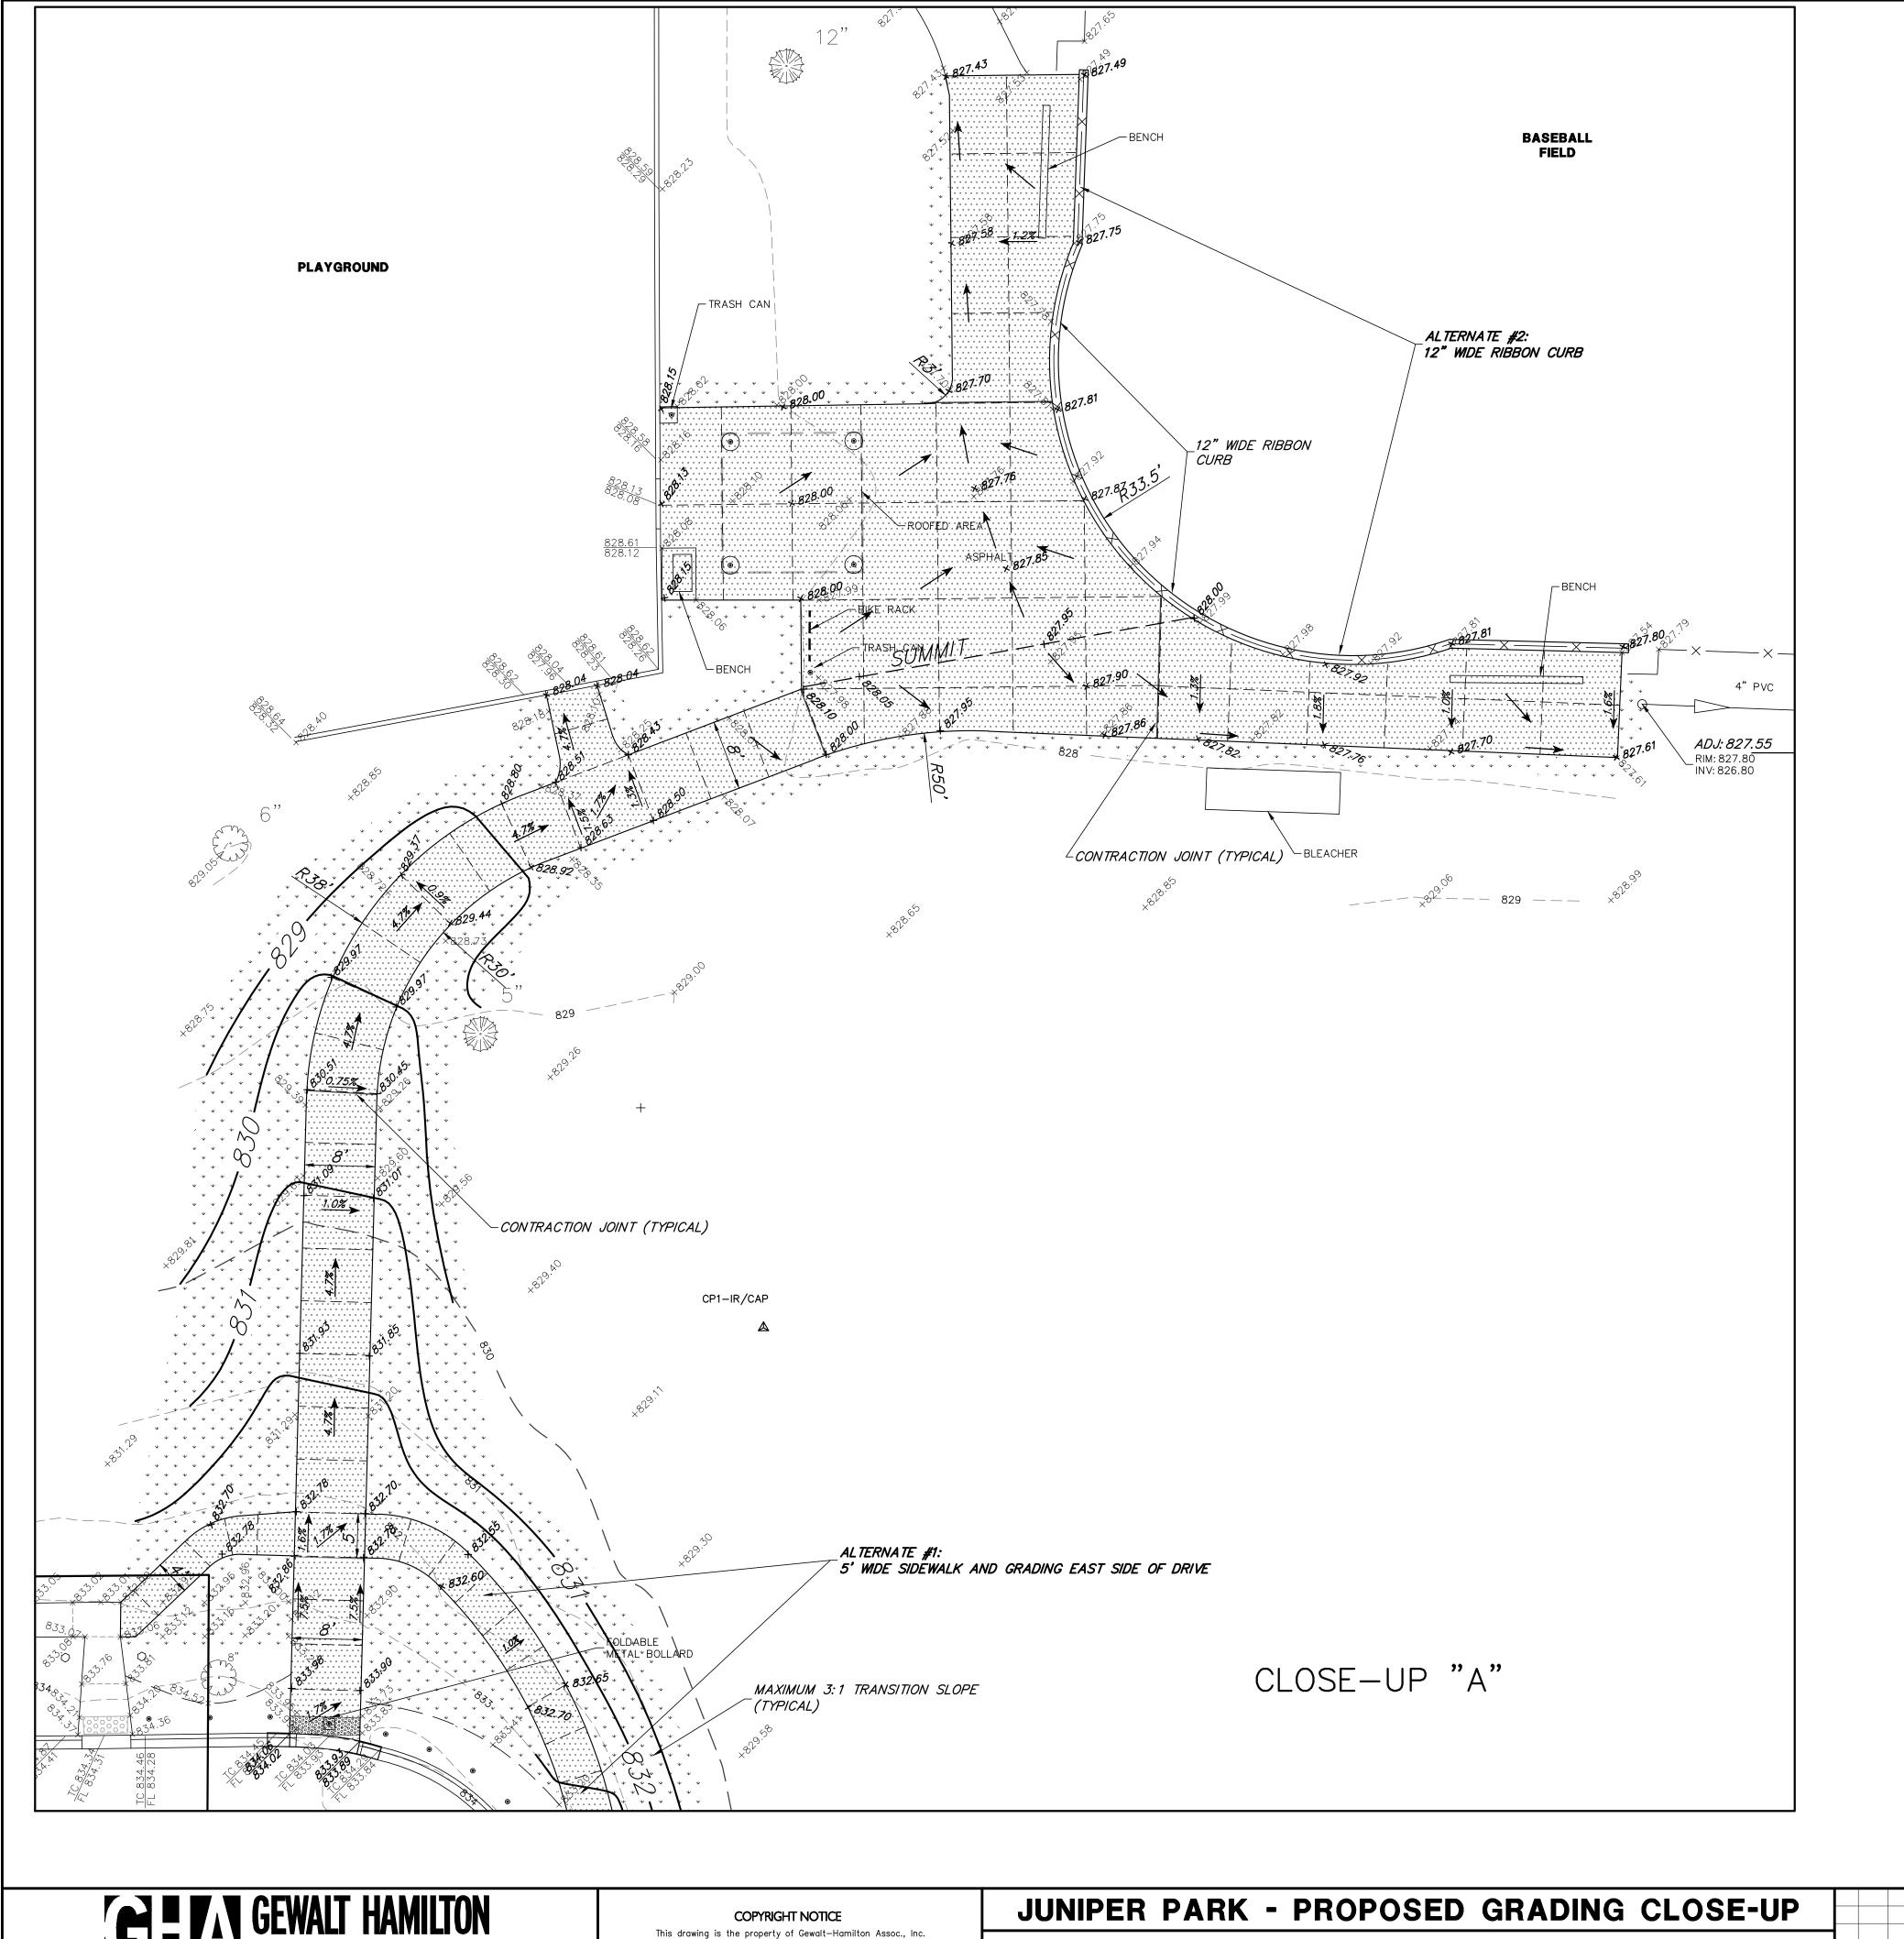



HMA SURFACE COURSE MIX D, N50, 2"

PCC SIDEWALK

TOPSOIL FURNISH AND PLACE, VARIABLE DEPTH SEEDING, CLASS 2A MULCH, METHOD 3A DETECTABLE WARNINGS

B6.12 CURB & GUTTER (REGULAR)

B6.12 CURB & GUTTER (ADA DEPRESSED)

\_\_\_\_\_\_\_ HMA SURFACE REMOVAL — BUTT JOINT ---- PAVEMENT SAWCUT

ADJ: ###.## STRUCTURE ADJUSTMENT TREE TRUNK PROTECTION FENCE

\_\_\_*SUMMIT*\_\_ SUMMITS SLOPES — ··· ← ··· ← SWALES

GRAPHIC SCALE ( IN FEET ) 1 inch = 10 ft.

\_ALTERNATE #1:
5' WIDE SIDEWALK AND GRADING EAST SIDE OF DRIVE

NEW ACCESIBLE

NEW ACCESIBLE

PARKING SIGN

SIGN

833

833 INTEGRATED B6 CURB NEW ACCESIBLE
PARKING SIGN
& POST NEW ACCESIBLE --PARKING SIGN & POST - ALTERNATE #1: REMOVE BOLLARD & FOUNDATION. SAWCUT & REMOVE 22 LF OF CURB & GUTTER. SAWCUT & REMOVE PAVEMENT TO ALLOW NEW CURB CLOSE-UP "B"

GEWALT HAMILTON ASSOCIATES, INC. 625 Forest Edge Drive Vernon Hills, IL. 60061


TEL 847.478.9700 FAX 847.478.9701


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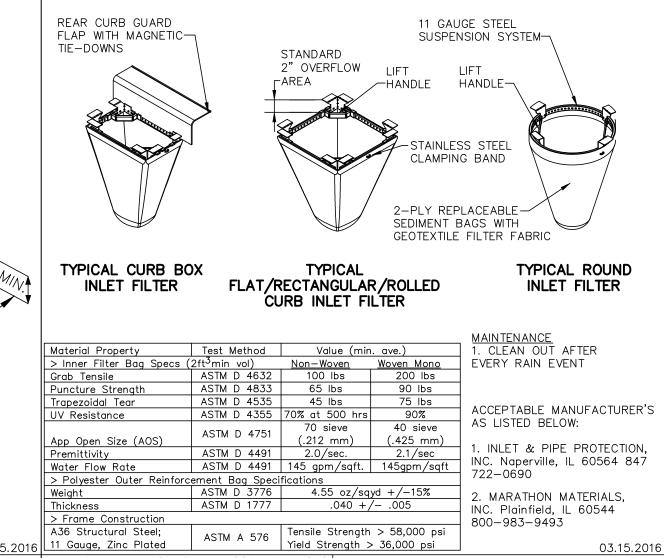
PROPOSED SITE IMPROVEMENTS PALATINE PARK DISTRICT PALATINE, ILLINOIS

		FILE: 5241.211_PR1.dwg
		DRAWN BY: AS GHA PROJECT # 5241.211
DATE	REVISION	CHECKED BY: TAR SCALE: DATE: 07-05-18 1" = 10'

SHEET NUMBER: OF 11 SHEETS



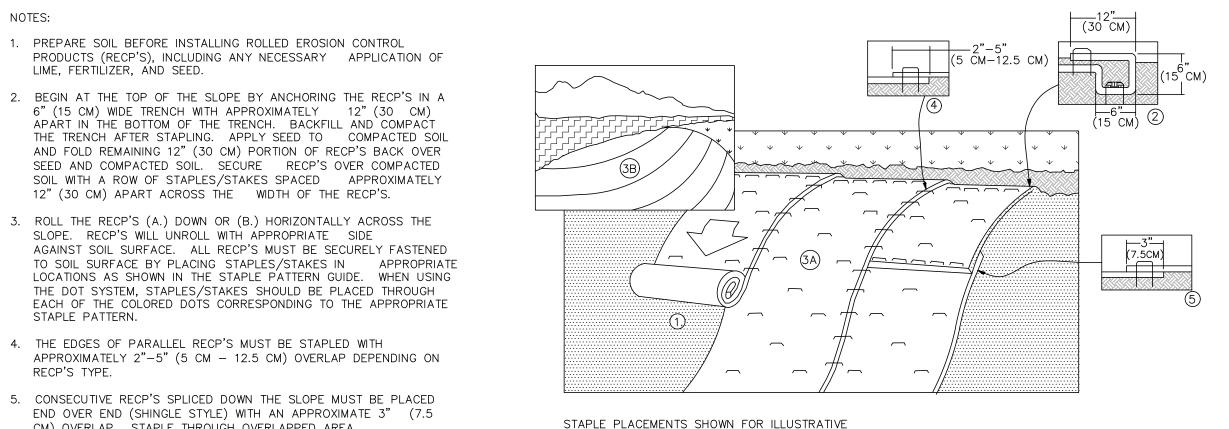

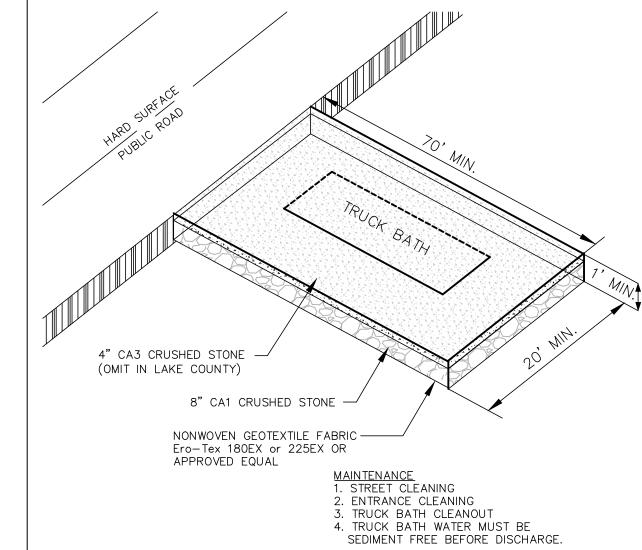

GENALT HAMILTON INLET FILTER BASKET DETAIL

## GENALT HAMILTON ASSOCIATES, INC.

NOTES:

LIME, FERTILIZER, AND SEED.

STAPLE PATTERN.

NOTE:

SECURE THE RECP'S.

- 1. SILT FENCE SHALL BE PLACED ON SLOPE CONTOURS TO MAXIMIZE PONDING EFFICIENCY.
- 2. INSPECT AND REPAIR FENCE AFTER EACH STORM EVENT AND REMOVE SEDIMENT WHEN NECESSARY. 9" (225mm) MAXIMUM RECOMMENDED STORAGE HEIGHT.

SLOPE. RECP'S WILL UNROLL WITH APPROPRIATE SIDE

CM) OVERLAP. STAPLE THROUGH OVERLAPPED AREA,

APPROXIMATELY 12" (30 CM) APART ACROSS ENTIRE RECP'S WIDTH.

\*IN LOOSE SOIL, CONDITIONS, THE USE OF STAPLE OR STAKE LENGTHS

GREATER THAN 6" (15 CM) MAY BE NECESSARY TO PROPERLY

- 3. REMOVED SEDIMENT SHALL BE DEPOSITED TO AN AREA THAT WILL NOT CONTRIBUTE SEDIMENT OFF-SITE AND CAN BE PERMANENTLY STABILIZED.
- 4. FABRIC AND INSTALLATION SHALL MEET THE REQUIREMENTS OF ASSHTO STANDARD SPECIFICATION M-288-00.
- 5. SLICING METHOD IS PREFERRED.

TEST PROCEDUR	E
ASTM D-4533	123 lbs
ASTM D-4833	101 lbs
ASTM D-4491	$0.05 \text{ sec}^{-1}$
ASTM D-4751	30 u.s. Sieve
ASTM D-4355	70%
	ASTM D-4833 ASTM D-4491 ASTM D-4751

- . SET POSTS AND EXCAVATE OR SLIT-TRENCH A 6-INCH DEEP TRENCH UPSLOPE ALONG THE LINE OF THE POST
- 2. ATTACH AASHTO GEOTEXTILE FILTER FABRIC TO EACH POST WITH A MINIMUM OF 3(THREE) FASTENERS PER POST AND EXTEND TO THE BOTTOM OF THE TRENCH. ACCEPTABLE FASTENERS INCLUDE STAPLES, ZIP-TIES, OR

2. THE CONCRETE WASHOUT SIGN SHALL BE INSTALLED

3. CONCRETE WASHOUT SHOULD NOT BE ALLOWED IN

STREET OR TO REACH A STORM WATER DRAINAGE

4. CONCRETE WASHOUT AREA TO BE LOCATED AT LEAST

10' BEHIND CURB IF ADJACENT TO A PAVED ROAD.

5. IF USING STRAW BALES, STAKE IN PLACE USING (2)

WITHIN 30 FT. OF THE TEMPORARY CONCRETE

#### EROSION CONTROL BLANKET SLOPE INSTALLATION

HARDWOOD OR METAL 2 NOMINAL THICKNESS

MAXIMUM SPACING

INSTALLATION WITHOUT TRENCHING

TIF DIRECT BURIED POST IS NOT PRACTICAL, CONSTRUCT WOOD BACK BRACED FRAME AND RUNNING 2X4 LATERAL BETWEEN POSTS. SUPPORT BACK BRACE WITH SANDBAGS,

FASTENERS (TYP.)

\_\_\_2 (TWO) INCH NOMINAL POSTS

CONTINOUSLY END TO END

SANDBAG 18" MIN.

-GEOTEXTILE FABRIC AASHTO M288

FABRIC EXTENSION UNDER

03.15.2016

PURPOSES ONLY. SEE STAPLE PATTERN GUIDES

FILTER FABRIC TO MEET-AASHTO M288 STANDARD

ATTACH FILTER FABRIC

SECURELY TO

POST

12" MIN.

(300mm)

TRENCH INSTALLATION

UPSTREAM SIDE OF

FOR ACTUAL RECOMMENDED PLACEMENTS.

**TEMPORARY** CONSTRUCTION ENTRANCE 11 Gauge, Zinc Plated

Permanent Seeding		A <b></b>		XXX	XXX	X 🚾		
Dormant Seeding	В■							
Dominant Seeding								
Temporary Seeding		С		×××	×××	X <b>E</b>		
Sodding		EXX	×					
Mulching	F							

| Stabilization Type: | JAN | FEB | MAR | APR | MAY | JUN | JUL | AUG | SEP | OCT | NOV | DEC |

- A = KENTUCKY BLUEGRASS @ 90 LBS/AC. MIXED WITH PERENNIAL RYEGRASS @ 30 LBS/AC. B = KENTUCKY BLUEGRASS @ 135 LBS/AC. MIXED WITH PERENNIAL RYEGRASS @ 45 LBS/AC.
- C = SPRING OATS @ 100 LBS/AC.D = WHEAT OR CEREAL RYE @ 150 LBS/AC.
- F = STRAW MULCH (HYDROMULCH OR USE STRAW BLANKET) @ 2 TONS/AC. XXX = IRRIGATION NEEDED
- IRRIGATION SHOULD BE PROVIDED AS NECESSARY TO THOROUGHLY ESTABLISH INTENDED GROWTH.
- SPRAYED ON PRODUCTS CANNOT BE USED NOV.-FEB.

### 3. BACKFILL AND COMPACT THE EXCAVATED SPOIL MATERIALS GEWALT HAMILTON ASSOCIATES, INC.

1. ACTUAL LAYOUT DETERMINED IN FIELD.

WASHOUT FACILITY.

SYSTEM OR WATERCOURSE.

2"X2"X4' WOODEN STAKES.

#### SILT FENCE INSTALLATION DETAIL

6. STRAW BALES SHALL BE TRENCHED IN 3". 7. CONCRETE WASHOUT DUMPSTER MAY BE USED IN LIEU OF CONSTRUCTION ONE AS DETAILED. 6" MIN HEIGHT CÓNCRETE OR 6' STEEL POST MIN. **WASHOUT** 

-4" X 4" X 6' WOOD POST -0.5" LAG SCREWS - PLYWOOD OR ALUMINUM 48" X 24" MIN

CONCRETE WASHOUT SIGN DETAIL

(OR EQUIVALENT) GEWALT HAMILTON ASSOCIATES, INC.

POST AND FABRIC

12" MIN.

(300 mm)

HEIGHT ABOVE

GROUND = 30 IN

10' MIN SANDBAG OR 6" WIRE STAPLE BARRIER WALL. FARTH BERM OR 30-MIL POLYETHYLENE STRAW BALE 0 0 0 0 0 -BARRIER WALL, EARTH BERM OR STRAW BALE NATIVE SOIL-ABOVE GRADE ANCHOR SECTION MAX -SANDBAG OR 6" WIRE STAPLE 30-MIL POLYETHYLENE-0000000 ELEVATION -SANDBAG OR 6" WIRE STAPLE (ANCHOR EVERY 2' ON TOP -NATIVE SOIL OF BARRIER) └-30-MIL POLYETHYLENE PLAN VIEW SUBGRADE ANCHOR SECTION MAINTENANCE: 1. DRIED CONCRETE WASTE SHALL BE PICKED UP AND DISPOSED OF PROPERLY WHEN 75% OF CAPACITY IS REACHED.


CONCRETE WASHOUT

2. HARDENED CONCRETE CAN BE PROPERLY RECYCLED AND REUSED

ONSITE OR HAULED OFF-SITE TO AN APPROPRIATE FACILITY.

## GEWALT HAMILTON ASSOCIATES, INC.

03.15.2016 TYPICAL SOIL

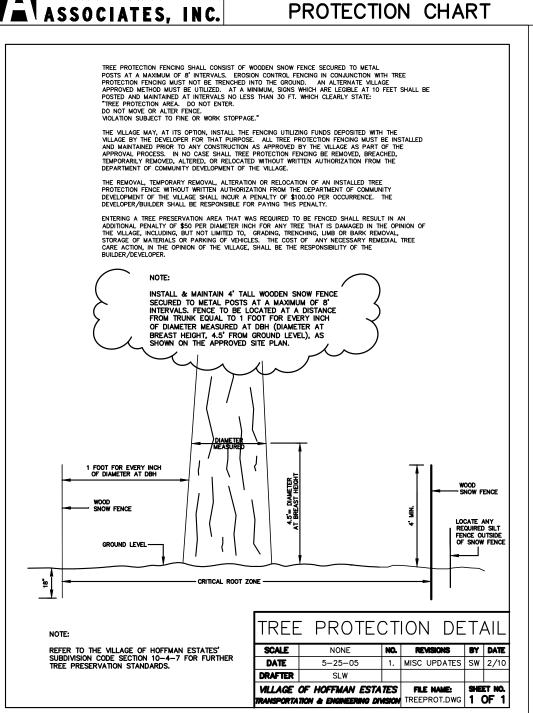

# ASSOCIATES, INC.

625 Forest Edge Drive Vernon Hills, IL. 60061

TEL 847.478.9700 FAX 847.478.9701

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### SOIL EROSION AND SEDIMENT CONTROL DETAILS

PROPOSED SITE IMPROVEMENTS PALATINE PARK DISTRICT PALATINE, ILLINOIS

			FILE: 5241.210 – DT1 Pale	ıtine Trail & Juniper Park.dwg	SHEET NUMBER:
			<b>DRAWN BY:</b> EJS <b>DATE:</b> 07–05–18	GHA PROJECT #	9
DATE	REVISION		<b>CHECKED BY:</b> TAR <b>DATE:</b> 07–05–18		OF 11 SHEETS

#### A. REFERENCED SPECIFICATIONS

 ALL CONSTRUCTION SHALL BE IN ACCORDANCE WITH THE APPLICABLE SECTIONS OF THE FOLLOWING, EXCEPT AS MODIFIED HEREIN OR ON THE PLANS: \* STANDARD SPECIFICATIONS FOR ROAD AND BRIDGE CONSTRUCTION (LATEST EDITION), BY THE

ILLINOIS DEPARTMENT OF TRANSPORTATION (IDOT SS) FOR ALL IMPROVEMENTS EXCEPT SANITARY

- SEWER AND WATER MAIN CONSTRUCTION; \* STANDARD SPECIFICATIONS FOR WATER AND SEWER MAIN CONSTRUCTION IN ILLINOIS, LATEST
- EDITION (SSWS) FOR SANITARY SEWER AND WATER MAIN CONSTRUCTION;

  \* VILLAGE OF \_\_PALATINE \_\_MUNICIPAL CODE;

  \* THE METROPOLITAN WATER RECLAMATION DISTRICT OF GREATER CHICAGO (MWRD) WATERSHED
- MANAGEMENT ORDINANCE AND TECHNICAL GUIDANCE MANUAL;

  \* IN CASE OF CONFLICT BETWEEN THE APPLICABLE ORDINANCES NOTED, THE MORE STRINGENT SHALL TAKE
- PRECEDENCE AND SHALL CONTROL ALL CONSTRUCTION.

- 1. THE MWRD LOCAL SEWER SYSTEMS SECTION FIELD OFFICE MUST BE NOTIFIED AT LEAST TWO (2) WORKING DAYS PRIOR TO THE COMMENCEMENT OF ANY WORK (CALL 708-588-4055).
- THE VILLAGE OF PALATINE ENGINEERING DEPARTMENT AND PUBLIC MUST BE NOTIFIED AT LEAST 24 HOURS PRIOR TO THE START OF CONSTRUCTION AND PRIOR TO EACH PHASE OF WORK. CONTRACTOR SHALL DETERMINE ITEMS REQUIRING INSPECTION PRIOR TO START OF CONSTRUCTION OR EACH WORK PHASE.
- 3. THE CONTRACTOR SHALL NOTIFY ALL UTILITY COMPANIES PRIOR TO BEGINNING CONSTRUCTION FOR THE EXACT LOCATIONS OF UTILITIES AND FOR THEIR PROTECTION DURING CONSTRUCTION. IF EXISTING UTILITIES ARE ENCOUNTERED THAT CONFLICT IN LOCATION WITH NEW CONSTRUCTION, IMMEDIATELY NOTIFY THE ENGINEER SO THAT THE CONFLICT CAN BE RESOLVED. CALL J.U.L.I.E. AT 1-800-892-0123.

- 1. ALL ELEVATIONS SHOWN ON PLANS REFERENCE THE NORTH AMERICAN VERTICAL DATUM OF 1988 (NAVD88). CONVERSION FACTOR IS \_\_\_\_
- 2. MWRD, THE MUNICIPALITY AND THE OWNER OR OWNER'S REPRESENTATIVE SHALL HAVE THE AUTHORITY TO INSPECT, APPROVE, AND REJECT THE CONSTRUCTION IMPROVEMENTS.
- THE CONTRACTOR(S) SHALL INDEMNIFY THE OWNER, ENGINEER, MUNICIPALITY, MWRD, AND THEIR AGENTS, ETC., FROM ALL LIABILITY INVOLVED WITH THE CONSTRUCTION, INSTALLATION, OR TESTING OF THIS WORK ON THE PROJECT.
- 4. THE PROPOSED IMPROVEMENTS MUST BE CONSTRUCTED IN ACCORDANCE WITH THE ENGINEERING PLANS AS APPROVED BY MWRD AND THE MUNICIPALITY UNLESS CHANGES ARE APPROVED BY MWRD, THE MUNICIPALITY, OR AUTHORIZED AGENT. THE CONSTRUCTION DETAILS, AS PRESENTED ON THE PLANS, MUST BE FOLLOWED. PROPER CONSTRUCTION TECHNIQUES MUST BE FOLLOWED ON THE IMPROVEMENTS INDICATED ON THE PLANS.
- THE LOCATION OF VARIOUS UNDERGROUND UTILITIES WHICH ARE SHOWN ON THE PLANS ARE FOR INFORMATION ONLY AND REPRESENT THE BEST KNOWLEDGE OF THE ENGINEER. VERIFY LOCATIONS AND ELEVATIONS PRIOR TO BEGINNING THE CONSTRUCTION OPERATIONS.
- 6. ANY EXISTING PAVEMENT, SIDEWALK, DRIVEWAY, ETC., DAMAGED DURING CONSTRUCTION OPERATIONS AND NOT CALLED FOR TO BE REMOVED SHALL BE REPLACED AT THE EXPENSE OF THE CONTRACTOR.
- 7. MATERIAL AND COMPACTION TESTING SHALL BE PERFORMED IN ACCORDANCE WITH THE REQUIREMENTS OF THE MUNICIPALITY, MWRD, AND OWNER.
- 8. THE UNDERGROUND CONTRACTOR SHALL MAKE ALL NECESSARY ARRANGEMENTS TO NOTIFY ALL INSPECTION AGENCIES.
- 9. ALL NEW AND EXISTING UTILITY STRUCTURES ON SITE AND IN AREAS DISTURBED DURING CONSTRUCTION SHALL BE ADJUSTED TO FINISH GRADE PRIOR TO FINAL INSPECTION.
- 10. RECORD DRAWINGS SHALL BE KEPT BY THE CONTRACTOR AND SUBMITTED TO THE ENGINEER AS SOON AS UNDERGROUND IMPROVEMENTS ARE COMPLETED. FINAL PAYMENTS TO THE CONTRACTOR SHALL BE HELD UNTIL THEY ARE RECEIVED. ANY CHANGES IN LENGTH, LOCATION OR ALIGNMENT SHALL BE SHOWN IN RED. ALL WYES OR BENDS SHALL BE LOCATED FROM THE DOWNSTREAM MANHOLE. ALL VALVES, B-BOXES, TEES OR BENDS SHALL BE TIED TO A FIRE HYDRANT.

#### D. SANITARY SEWER

- 1. THE CONTRACTOR SHALL TAKE MEASURES TO PREVENT ANY POLLUTED WATER, SUCH AS GROUND AND SURFACE WATER, FROM ENTERING THE EXISTING SANITARY SEWERS.
- 2. A WATER-TIGHT PLUG SHALL BE INSTALLED IN THE DOWNSTREAM SEWER PIPE AT THE POINT OF SEWER CONNECTION PRIOR TO COMMENCING ANY SEWER CONSTRUCTION. THE PLUG SHALL REMAIN IN PLACE UNTIL REMOVAL IS AUTHORIZED BY THE MUNICIPALITY AND/OR MWRD AFTER THE SEWERS HAVE BEEN TESTED AND ACCEPTED.
- 3. DISCHARGING ANY UNPOLLUTED WATER INTO THE SANITARY SEWER SYSTEM FOR THE PURPOSE OF SEWER FLUSHING OF LINES FOR THE DEFLECTION TEST SHALL BE PROHIBITED WITHOUT PRIOR APPROVAL FROM THE MUNICIPALITY OR MWRD.
- 4. ALL SANITARY SEWER CONSTRUCTION SHALL BE IN ACCORDANCE WITH THE STANDARD SPECIFICATIONS FOR WATER AND SEWER MAIN CONSTRUCTION IN ILLINOIS (LATEST EDITION).
- 5. ALL FLOOR DRAINS SHALL DISCHARGE TO THE SANITARY SEWER SYSTEM.
- 6. ALL DOWNSPOUTS AND FOOTING DRAINS SHALL DISCHARGE TO THE STORM SEWER SYSTEM.
- 7. ALL SANITARY SEWER PIPE MATERIALS AND JOINTS (AND STORM SEWER PIPE MATERIALS AND JOINTS IN A COMBINED SEWER AREA) SHALL CONFORM TO THE FOLLOWING:

ı			
I	PIPE MATERIAL	PIPE SPECIFICATIONS	JOINT SPECIFICATIONS
	VITRIFIED CLAY PIPE	ASTM C-700	ASTM C-425
	REINFORCED CONCRETE SEWER PIPE	ASTM C-76	ASTM C-443
	CAST IRON SOIL PIPE	ASTM A-74	ASTM C-564
	DUCTILE IRON PIPE	ANSI A21.51	ANSI A21.11
	POLYVINYL CHLORIDE (PVC) PIPE 6-INCH TO 15-INCH DIAMETER SDR 26 18-INCH TO 27-INCH DIAMETER F/DY=46	ASTM D-3034 ASTM F-679	ASTM D-3212 ASTM D-3212
I	HIGH DENSITY POLYETHYLENE (HDPE)	ASTM D-3350 ASTM D-3035	ASTM D-3261,F-2620 (HEAT FUSION) ASTM D-3212,F-477 (GASKETED)
	WATER MAIN QUALITY PVC 4-INCH TO 36-INCH 4-INCH TO 12-INCH 14-INCH TO 48-INCH	ASTM D-2241 AWWA C900 AWWA C905	ASTM D-3139 ASTM D-3139 ASTM D-3139

THE FOLLOWING MATERIALS ARE ALLOWED ON A QUALIFIED BASIS SUBJECT TO DISTRICT REVIEW AND APPROVAL PRIOR TO PERMIT ISSUANCE. A SPECIAL CONDITION WILL BE ADDED TO THE PERMIT WHEN THE PIPE MATERIAL BELOW IS USED FOR SEWER CONSTRUCTION OR A CONNECTION IS MADE.


PIPE MATERIAL POLYPROPYLENE (PP) PIPE	PIPE SPECIFICATIONS	JOINT SPECIFICATIONS
12-INCH TO 24-INCH DOUBLE WALL	ASTM F-2736	D-3212, F-477
30-INCH TO 60-INCH TRIPLE WALL	ASTM F-2764	D3212, F-477

- ALL SANITARY SEWER CONSTRUCTION (AND STORM SEWER CONSTRUCTION IN COMBINED SEWER AREAS), REQUIRES STONE BEDDING WITH STONE ¼ "TO 1" IN SIZE, WITH MINIMUM BEDDING THICKNESS EQUAL TO ¼ THE OUTSIDE DIAMETER OF THE SEWER PIPE, BUT NOT LESS THAN FOUR (4) INCHES NOR MORE THAN EIGHT (8) INCHES. MATERIAL SHALL BE CA-7, CA-11 OR CA-13 AND SHALL BE EXTENDED AT LEAST 12' ABOVE THE TOP OF THE PIPE WHEN USING PVC.
- 9. NON-SHEAR FLEXIBLE-TYPE COUPLINGS SHALL BE USED IN THE CONNECTION OF SEWER PIPES OF DISSIMILAR PIPE MATERIALS.
- 10. ALL MANHOLES SHALL BE PROVIDED WITH BOLTED, WATERTIGHT COVERS. SANITARY LIDS SHALL BE CONSTRUCTED WITH A CONCEALED PICKHOLE AND WATERTIGHT GASKET WITH THE WORD "SANITARY" CAST INTO THE LID.
- 11. WHEN CONNECTING TO AN EXISTING SEWER MAIN BY MEANS OTHER THAN AN EXISTING WYE, TEE, OR AN EXISTING MANHOLE, ONE OF THE FOLLOWING METHODS SHALL BE USED: a) A CIRCULAR SAW-CUT OF SEWER MAIN BY PROPER TOOLS ("SHEWER-TAP" MACHINE OR SIMILAR) AND PROPER INSTALLATION OF HUBWYE SADDLE OR HUB-TEE SADDLE.
- A WYE OR TEE BRANCH SECTION. c) WITH PIPE CUTTER, NEATLY AND ACCURATELY CUT OUT DESIRED LENGTH OF PIPE FOR INSERTION OF PROPER FITTING, USING "BAND SEAL" OR SIMILAR COUPLINGS TO HOLD IT FIRMLY IN PLACE.

b) REMOVE AN ENTIRE SECTION OF PIPE (BREAKING ONLY THE TOP OF ONE BELL) AND REPLACE WITH

- 12. WHENEVER A SANITARY/COMBINED SEWER CROSSES UNDER A WATERMAIN, THE MINIMUM VERTICAL DISTANCE FROM THE TOP OF THE SEWER TO THE BOTTOM OF THE WATERMAIN SHALL BE 18 INCHES. FURTHERMORE, A MINIMUM HORIZONTAL DISTANCE OF 10 FEET BETWEEN SANITARY/COMBINED SEWERS AND WATERMAINS SHALL BE MAINTAINED UNLESS: THE SEWER IS LAID IN A SEPARATE TRENCH, KEEPING A MINIMUM 18" VERTICAL SEPARATION; OR THE SEWER IS LAID IN THE SAME TRENCH WITH THE WATERMAIN LOCATED AT THE OPPOSITE SIDE ON A BENCH OF UNDISTURBED EARTH, KEEPING A MINIMUM 18" VERTICAL SEPARATION. IF EITHER THE VERTICAL OR HORIZONTAL DISTANCES DESCRIBED CANNOT BE MAINTAINED, OR THE SEWER CROSSES ABOVE THE WATER MAIN, THE SEWER SHALL BE CONSTRUCTED TO WATER MAIN STANDARDS OR IT SHALL BE ENCASED WITH A WATER MAIN QUALITY CARRIER PIPE WITH THE ENDS SEALED.
- 13. ALL EXISTING SEPTIC SYSTEMS SHALL BE ABANDONED. ABANDONED TANKS SHALL BE FILLED WITH GRANULAR MATERIAL OR REMOVED.
- 14. ALL SANITARY MANHOLES, (AND STORM MANHOLES IN COMBINED SEWER AREAS), SHALL HAVE A MINIMUM INSIDE DIAMETER OF 48 INCHES, AND SHALL BE CAST IN PLACE OR PRE-CAST REINFORCED
- 15. ALL SANITARY MANHOLES, (AND STORM MANHOLES IN COMBINED SEWER AREAS), SHALL HAVE PRECAST "RUBBER BOOTS" THAT CONFORM TO ASTM C-923 FOR ALL PIPE CONNECTIONS. PRECAST SECTIONS SHALL CONSIST OF MODIFIED GROOVE TONGUE AND RUBBER GASKET TYPE JOINTS.
- 16. ALL ABANDONED SANITARY SEWERS SHALL BE PLUGGED AT BOTH ENDS WITH AT LEAST 2 FEET LONG NON-SHRINK CONCRETE OR MORTAR PLUG.
- 17. EXCEPT FOR FOUNDATION/FOOTING DRAINS PROVIDED TO PROTECT BUILDINGS, OR PERFORATED PIPES ASSOCIATED WITH VOLUME CONTROL FACILITIES, DRAIN TILES/FIELD TILES/UNDERDRAINS/PERFORATED PIPES ARE NOT ALLOWED TO BE CONNECTED TO OR TRIBUTARY TO COMBINED SEWERS, SANITARY SEWERS, OR STORM SEWERS TRIBUTARY TO COMBINED SEWERS IN COMBINED SEWER ÁREAS. CONSTRUCTION OF NEW FACILITIES OF THIS TYPE IS PROHIBITED; AND ALL EXISTING DRAIN TILES AND PERFORATED PIPES ENCOUNTERED WITHIN THE PROJECT AREA SHALL BE PLUGGED OR REMOVED, AND SHALL NOT BE CONNECTED TO COMBINED SEWERS, SANITARY SEWERS, OR STORM SEWERS TRIBUTARY TO COMBINED SEWERS.
- A BACKFLOW PREVENTER IS REQUIRED FOR ALL DETENTION BASINS TRIBUTARY TO COMBINED SEWERS. REQUIRED BACKFLOW PREVENTERS SHALL BE INSPECTED AND EXERCISED ANNUALLY BY THE PROPERTY OWNER TO ENSURE PROPER OPERATION, AND ANY NECESSARY MAINTENANCES SHALL BE PERFORMED TO ENSURE FUNCTIONALITY. IN THE EVENT OF A SEWER SURCHARGE INTO AN OPEN DETENTION BASIN TRIBUTARY TO COMBINED SEWERS, THE PERMITTEE SHALL ENSURE THAT CLEAN UP AND WASH OUT OF SEWAGE TAKES PLACE WITHIN 48 HOURS OF THE STORM EVENT.

- 1. THE CONTRACTOR SHALL INSTALL THE EROSION AND SEDIMENT CONTROL DEVICES AS SHOWN ON THE APPROVED EROSION AND SEDIMENT CONTROL PLAN.
- 2. EROSION AND SEDIMENT CONTROL PRACTICES SHALL BE FUNCTIONAL PRIOR TO HYDROLOGIC DISTURBANCE OF THE SITE.
- ALL DESIGN CRITERIA, SPECIFICATIONS, AND INSTALLATION OF EROSION AND SEDIMENT CONTROL PRACTICES SHALL BE IN ACCORDANCE WITH THE ILLINOIS URBAN MANUAL.
- 4. A COPY OF THE APPROVED EROSION AND SEDIMENT CONTROL PLAN SHALL BE MAINTAINED ON THE SITE AT ALL TIMES.
- 5. INSPECTIONS AND DOCUMENTATION SHALL BE PERFORMED, AT A MINIMUM: a) UPON COMPLETION OF INITIAL EROSION AND SEDIMENT CONTROL MEASURES, PRIOR TO ANY
- SOIL DISTURBANCE. b) ONCE EVERY SEVEN (7) CALENDAR DAYS AND WITHIN 24 HOURS OF THE END OF A STORM EVENT WITH GREATER THAN 0.5 INCH OF RAINFALL OR LIQUID EQUIVALENT PRECIPITATION.
- SOIL DISTURBANCE SHALL BE CONDUCTED IN SUCH A MANNER AS TO MINIMIZE EROSION IF STRIPPING, CLEARING, GRADING, OR LANDSCAPING ARE TO BE DONE IN PHASES, THE CO-PERMITTEE SHALL PLAN FOR APPROPRIATE SOIL EROSION AND SEDIMENT CONTROL MEASURES.
- 7. A STABILIZED MAT OF CRUSHED STONE MEETING THE STANDARDS OF THE ILLINOIS URBAN MANUAL SHALL BE INSTALLED AT ANY POINT WHERE TRAFFIC WILL BE ENTERING OR LEAVING A CONSTRUCTION SITE. SEDIMENT OR SOIL REACHING AN IMPROVED PUBLIC RIGHT-OF-WAY, STREET, ALLEY OR PARKING AREA SHALL BE REMOVED BY SCRAPING OR STREET CLEANING AS ACCUMULATIONS WARRANT AND TRANSPORTED TO A CONTROLLED SEDIMENT DISPOSAL AREA.
- 8. CONCRETE WASHOUT FACILITIES SHALL BE CONSTRUCTED IN ACCORDANCE WITH THE ILLINOIS URBAN MANUAL AND SHALL BE INSTALLED PRIOR TO ANY ON SITE CONSTRUCTION ACTIVITIES INVOLVING CONCRETE.
- 9. MORTAR WASHOUT FACILITIES SHALL BE CONSTRUCTED IN ADDITION TO CONCRETE WASHOUT FACILITIES FOR ANY BRICK AND MORTAR BUILDING ENVELOPE CONSTRUCTION ACTIVITIES.
- 10. TEMPORARY DIVERSIONS SHALL BE CONSTRUCTED AS NECESSARY TO DIRECT ALL RUNOFF FROM HYDROLOGICALLY DISTURBED AREAS TO AN APPROPRIATE SEDIMENT TRAP OR BASIN. VOLUME CONTROL FACILITIES SHALL NOT BE USED AS TEMPORARY SEDIMENT BASINS.
- 12. DISTURBED AREAS OF THE SITE WHERE CONSTRUCTION ACTIVITIES HAVE TEMPORARILY OR PERMANENTLY CEASED SHALL BE STABILIZED WITH TEMPORARY OR PERMANENT MEASURES WITHIN
- 13. ALL FLOOD PROTECTION AREAS AND VOLUME CONTROL FACILITIES SHALL, AT A MINIMUM, BE PROTECTED WITH A DOUBLE-ROW OF SILT FENCE (OR EQUIVALENT).
- 14. VOLUME CONTROL FACILITIES SHALL NOT BE CONSTRUCTED UNTIL ALL OF THE CONTRIBUTING DRAINAGE AREA HAS BEEN STABILIZED.
- 15. SOIL STOCKPILES SHALL, AT A MINIMUM, BE PROTECTED WITH PERIMETER SEDIMENT CONTROLS. SOIL STOCKPILES SHALL NOT BE PLACED IN FLOOD PROTECTION AREAS OR THEIR BUFFERS.
- 16. EARTHEN EMBANKMENT SIDE SLOPES SHALL BE STABILIZED WITH APPROPRIATE EROSION CONTROL
- 17. STORM SEWERS THAT ARE OR WILL BE FUNCTIONING DURING CONSTRUCTION SHALL BE PROTECTED BY APPROPRIATE SEDIMENT CONTROL MEASURES.
- 18. THE CONTRACTOR SHALL EITHER REMOVE OR REPLACE ANY EXISTING DRAIN TILES AND INCORPORATE THEM INTO THE DRAINAGE PLAN FOR THE DEVELOPMENT. DRAIN TILES CANNOT BE TRIBUTARY TO A SANITARY OR COMBINED SEWER. DRAIN TILES ALLOWED IN COMBINED SEWER AREA FOR GREEN INFRASTRUCTURE PRACTICES.
- 19. IF DEWATERING SERVICES ARE USED, ADJOINING PROPERTIES AND DISCHARGE LOCATIONS SHALL BE PROTECTED FROM EROSION AND SEDIMENTATION. DEWATERING SYSTEMS SHOULD BE INSPECTED DAILY DURING OPERATIONAL PERIODS. THE SITE INSPECTOR MUST BE PRESENT AT THE COMMENCEMENT OF DEWATERING ACTIVITIES.
- 20. THE CONTRCTOR SHALL BE RESPONSIBLE FOR TRENCH DEWATERING AND EXCAVATION FOR THE INSTALLATION OF SANITARY SEWERS, STORM SEWERS, WATERMAINS AS WELL AS THEIR SERVICES AND OTHER APPURTENANCES. ANY TRENCH DEWATERING, WHICH CONTAINS SEDIMENT SHALL PASS THROUGH A SEDIMENT SETTLING POND OR EQUALLY EFFECTIVE SEDIMENT CONTROL DEVICE. ALTERNATIVES MAY INCLUDE DEWATERING INTO A SUMP PIT, FILTER BAG OR EXISTING VEGETATED UPSLOPE AREA. SEDIMENT LADEN WATERS SHALL NOT BE DISCHARGE TO WATERWAYS, FLOOD PROTECTION AREAS OR THE COMBINED SEWER SYSTEM.
- 21. ALL PERMANENT EROSION CONTROL PRACTICES SHALL BE INITIATED WITHIN SEVEN (7) DAYS FOLLOWING THE COMPLETION OF SOIL DISTURBING ACTIVITIES.
- 22. ALL EROSION AND SEDIMENT CONTROL MEASURES SHALL BE MAINTAINED AND REPAIRED AS NEEDED ON A YEAR-ROUND BASIS DURING CONSTRUCTION AND ANY PERIODS OF CONSTRUCTION SHUTDOWN UNTIL PERMANENT STABILIZATION IS ACHIEVED.
- 23. ALL TEMPORARY EROSION AND SEDIMENT CONTROL MEASURES SHALL BE REMOVED WITHIN THIRTY (30) DAYS AFTER PERMANENT SITE STABILIZATION.
- 24. THE EROSION AND SEDIMENT CONTROL MEASURES SHOWN ON THE PLANS ARE THE MINIMUM REQUIREMENTS. ADDITIONAL MEASURES MAY BE REQUIRED, AS DIRECTED BY THE ENGINEER, SITE INSPECTOR, OR MWRD.

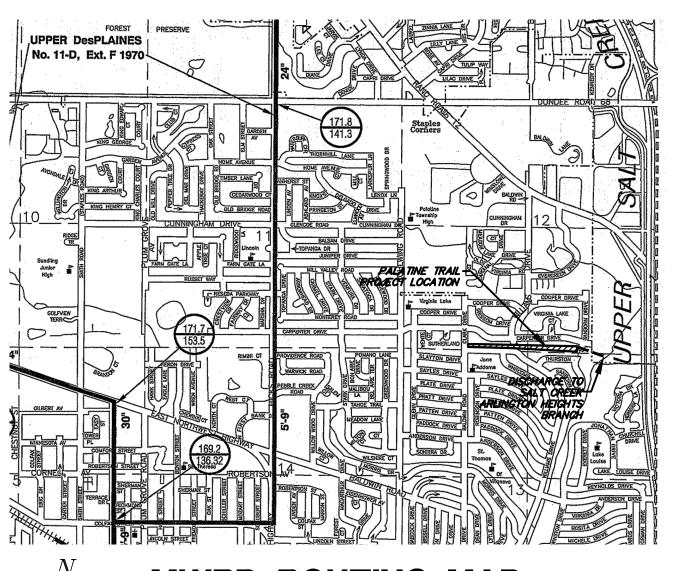

MWRD ROUTING MAP FOR PALATINE TRAIL

**SCALE 1"=2000'** 

TECHNICAL GUIDANCE MANUAL

MWRD GENERAL NOTES

07/12/2016

STD. DWG. NO.18

PAGE NO. 19

GHA PROJECT #

SCALE:

5241.300

GEWALT HAMILTON ASSOCIATES, INC. 625 Forest Edge Drive Vernon Hills, IL. 60061

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**MWRD GENERAL NOTES** 

PROPOSED SITE IMPROVEMENTS PALATINE PARK DISTRICT PALATINE, ILLINOIS

FILE: 5241.210 — DT1 Palatine Trail & Juniper Park.dwg **DRAWN BY:** EJS **DATE:** 07-05-18 **CHECKED BY:** TAR **DATE:** 07-05-18 NO. BY DATE REVISION

SHEET NUMBER:

OF 11 SHEETS

#### GENERAL NOTES


- 1. ALL CONSTRUCTION SHALL BE PERFORMED ACCORDING TO THE ILLINOIS DEPARTMENT OF TRANSPORTATION "STANDARD SPECIFICATIONS FOR ROAD AND BRIDGE CONSTRUCTION" LATEST EDITION, THE "SUPPLEMENTAL SPECIFICATIONS AND RECURRING SPECIAL PROVISIONS" LATEST EDITION, THE "STANDARD SPECIFICATIONS FOR WATER AND SEWER MAIN CONSTRUCTION IN ILLINOIS" LATEST EDITION, THE DETAILS IN THESE PLANS, THE CONTRACT DOCUMENTS, ALL APPLICABLE REQUIREMENTS OF THE ILLINOIS DEPARTMENT OF TRANSPORTATION, THE IEPA AND ORDINANCES OF AUTHORITIES HAVING JURISDICTION AND ALL ADDENDA THERETO.
- 2. EASEMENTS FOR THE EXISTING UTILITIES, BOTH PUBLIC AND PRIVATE AND UTILITIES WITHIN PUBLIC RIGHTS—OF—WAY ARE SHOWN ON THE PLANS ACCORDING TO AVAILABLE RECORDS. THE CONTRACTOR SHALL BE RESPONSIBLE FOR DETERMINING THE EXACT LOCATION IN THE FIELD OF THESE UTILITY LINES AND THEIR PROTECTION FROM DAMAGE DUE TO CONSTRUCTION OPERATIONS. IF EXISTING UTILITY LINES OF ANY NATURE ARE ENCOUNTERED WHICH CONFLICT WITH NEW CONSTRUCTION, THE CONTRACTOR SHALL NOTIFY THE ENGINEER IMMEDIATELY SO THAT THE CONFLICT MAY BE RESOLVED.
- 3. WHENEVER, DURING CONSTRUCTION OPERATIONS, ANY LOOSE MATERIAL IS DEPOSITED IN THE FLOW LINE OF GUTTERS, DRAINAGE STRUCTURES, DITCHES, ETC. SUCH THAT THE NATURAL FLOW LINE OF WATER IS OBSTRUCTED, THE LOOSE MATERIAL WILL BE REMOVED AT THE CLOSE OF EACH WORKING DAY. AT THE CONCLUSION OF CONSTRUCTION OPERATIONS, ALL DRAINAGE STRUCTURES AND FLOW LINES SHALL BE FREE FROM DIRT AND DEBRIS. THIS WORK SHALL BE CONSIDERED INCLUDED IN THE CONTRACT. THE CONTRACTOR'S FAILURE TO PROVIDE THE ABOVE WILL PRECLUDE ANY POSSIBLE ADDED COMPENSATION REQUESTED DUE TO DELAYS OR UNSUITABLE MATERIALS CREATED AS A RESULT THEREOF.
- 4. THE CONTRACTOR SHALL VERIFY ALL DIMENSIONS AND EXISTING CONDITIONS AFFECTING THEIR WORK WITH THE ACTUAL CONDITIONS AT THE JOB SITE PRIOR TO ORDERING MATERIALS. IN ADDITION, THE CONTRACTOR MUST VERIFY THE LINE AND GRADES. IF THERE ARE ANY DISCREPANCIES FROM WHAT IS SHOWN ON THE CONSTRUCTION PLANS, STANDARD SPECIFICATIONS AND/OR SPECIAL DETAILS, THE CONTRACTOR SHALL SECURE WRITTEN INSTRUCTION FROM THE ENGINEER PRIOR TO PROCEEDING WITH ANY PART OF THE WORK AFFECTED BY OMISSION OR DISCREPANCIES. FAILING TO SECURE SUCH INSTRUCTION, THE CONTRACTOR WILL BE CONSIDERED TO HAVE PROCEEDED AT HIS/HER OWN RISK AND EXPENSE AND NO ADDITIONAL COMPENSATION WILL BE PROVIDED FOR ANY COSTS INCURRED..
- 5. ALL PAVEMENT DIMENSIONS ARE SHOWN TO EDGE OF PAVEMENT UNLESS OTHERWISE NOTED.
- 6. WHERE SECTION OR SUBSECTION MONUMENTS ARE ENCOUNTERED, THE ENGINEER SHALL BE NOTIFIED BEFORE THE MONUMENTS ARE REMOVED. THE CONTRACTOR SHALL CAREFULLY PRESERVE ALL PROPERTY MARKS AND MONUMENTS UNTIL THE OWNER, AUTHORIZED SURVEYOR OR AGENT HAS WITNESSED OR OTHERWISE REFERENCED THEIR LOCATION.
- 7. THE CONTRACTOR SHALL NOTIFY THE ENGINEER AT LEAST 72 HOURS PRIOR TO BEGINNING WORK.
- 8. IF DURING CONSTRUCTION THE CONTRACTOR ENCOUNTERS OR OTHERWISE BECOMES AWARE OF ANY SEWERS OR UNDERDRAINS OTHER THAN THOSE SHOWN ON THE PLANS, HE/SHE SHALL INFORM THE ENGINEER, WHO SHALL DIRECT THE WORK NECESSARY TO MAINTAIN OR REPLACE THE FACILITIES IN SERVICE AND TO PROTECT THEM FROM DAMAGE DURING CONSTRUCTION IF MAINTAINED. EXISTING FACILITIES TO BE MAINTAINED THAT ARE DAMAGED BECAUSE OF NON—COMPLIANCE WITH THIS PROVISION SHALL BE REPLACED AT THE CONTRACTOR'S OWN EXPENSE.
- 9. THE CONTRACTOR SHALL PROVIDE TEMPORARY TOILET FACILITIES AND HAND SANITIZING STATIONS FOR THE USE OF ALL THE CONTRACTORS PERSONNEL EMPLOYED ON THE WORK SITE. THE FACILITIES SHALL BE MAINTAINED IN PROPER SANITARY CONDITION THROUGHOUT THE PROJECT. THE LOCATION OF THE TEMPORARY FACILITIES SHALL BE APPROVED BY THE ENGINEER.
- 10. THE CONTRACTOR IS RESPONSIBLE FOR COMPLYING WITH THE NPDES PERMIT AND SWPPP MANUAL. IF NO NPDES PERMIT OR SWPPP MANUAL IS NEEDED FOR THE PROJECT THE CONTRACTOR SHALL PERFORM SOIL EROSION SEDIMENT CONTROL BEST PRACTICES OR AS DIRECTED BY THE OWNER TO PREVENT ILLICIT DISCHARGES FROM THE SITE.

#### UTILITY NOTES


- 1. UNDERGROUND WORK SHALL INCLUDE TRENCHING, DISPOSAL OF EXCESS MATERIAL, DEWATERING, INSTALLATION OF PIPE, CASTINGS, STRUCTURES, BACKFILLING OF TRENCHES AND COMPACTION, AND TESTING AS SHOWN ON THE CONSTRUCTION PLANS. FITTINGS AND ACCESSORIES NECESSARY TO COMPLETE THE WORK MAY NOT BE SPECIFIED BUT SHALL BE CONSIDERED AS INCLUDED TO THE COST OF THE CONTRACT. ALL SEWER SHALL BE INSTALLED USING A LASER AND BEGIN AT THE DOWNSTREAM END.
- 2. THE CONTRACTOR IS RESPONSIBLE FOR COMPLYING WITH (225 ILCS 320/)THE ILLINOIS PLUMBING LICENSING LAW FOR THE INSTALLATION PLUMBING AND PLUMBING SYSTEMS AS DEFINED THEREIN.
- 3. MACHINE CORE ALL CONNECTIONS TO EXISTING STRUCTURES USING A CORE DRILL. HAMMERING OR SAWING OF STRUCTURES WILL NOT BE ALLOWED.
- 4. SANITARY SERVICE CONNECTIONS TO NEW SEWERS SHALL BE MADE WITH WYE BRANCHES. WYE BRANCHES SHALL BE FACTORY MANUFACTURED PERMANENTLY AFFIXED TO THE MAIN SEWER. TEE BRANCHES ARE NOT ALLOWED.
- 5. ALL CONNECTIONS TO EXISTING SANITARY MANHOLES SHALL BE INSTALLED WITH A NEOPRENE BOOT SECURED WITH DOUBLE STAINLESS STEEL STRAPS MEETING THE REQUIREMENTS OF ASTM C-923.
- 6. ALL CONNECTIONS TO EXISTING OR DISSIMILAR STORM/SANITARY LINES SHALL BE DONE WITH STAINLESS STEEL NON-SHEAR COUPLINGS.
- 7. STONE BEDDING AND BACKFILL SHALL BE OMITTED FOR A DISTANCE OF 15 FEET UP AND DOWNSTREAM OF SEWERS DRAINING TO OR FROM PONDS OR STREAMS. THE REPLACED BEDDING SHALL BE SILTY CLAY SOIL MECHANICALLY COMPACTED TO 90% MODIFIED PROCTOR DENSITY. THE USE OF PERMEABLE SOILS WILL NOT BE PERMITTED.
- 8. ALL WATER MAIN SHALL HAVE MECHANICAL RESTRAINED TYPE JOINTS AT ALL CONNECTIONS AND FITTINGS. IN ADDITION, ALL HARDWARE SHALL BE STAINLESS STEEL.
- 9. THRUST BLOCKING SHALL BE PROVIDED ON WATER MAIN AT ALL BENDS, TEES, ELBOWS, ETC. INDIVIDUAL INSPECTION FOR ALL THRUST BLOCKING IS REQUIRED. THRUST BLOCKING SHALL BE POURED IN PLACE CONCRETE. PRECAST BLOCKS MAY BE USED AS APPROVED BY THE ENGINEER IN THE FIELD.
- 10. ALL FLOOR DRAINS SHALL DISCHARGE TO THE SANITARY SEWER. ALL DOWNSPOUTS, SIDE YARD DRAINS, AND OUTSIDE DRAINS SHALL DISCHARGE TO THE STORM SEWER SYSTEM. FOOTING DRAINS SHALL FIRST DRAIN TO A SUMP PIT.
- 11. BUILDING STORM SEWER SERVICE PIPE SHALL NOT BE LESS THAN THE DIAMETER OF THE PLUMBING PIPE FROM THE BUILDING, BUT NOT LESS THAN 6 INCHES. THE PIPE SHALL HAVE A MINIMUM SLOPE OF 1/8-INCH PER FOOT, BUT NOT MORE THAN 1/2-INCH PER FOOT. CHANGES OF DIRECTION OF SERVICE PIPE SHALL BE MADE WITH COMBINATIONS OF 22-1/2 DEGREE BENDS WHEREVER PRACTICABLE, WITH NOT LESS THAN 2 FEET OF STRAIGHT PIPE BETWEEN SUCH BENDS. RIGHT ANGLE (90 DEGREE) BENDS WILL NOT BE ALLOWED. WHEN A SERVICE LINE-EXCEEDS 100 FEET IN LENGTH, A CLEANOUT SHALL BE PROVIDED AT A LOCATION DESIGNATED BY THE ENGINEER. THE CLEANOUT SHALL BE PROPERLY SEALED, WITH THE TOP OF THE PLUGGED RISER FLUSH WITH FINISHED GRADE.


#### PROJECT SPECIFIC NOTES

- 1. ALL WORK PERFORMED UNDER THIS CONTRACT SHALL BE GUARANTEED BY THE CONTRACTOR AND HIS SURETY FOR A PERIOD OF 12 MONTHS FROM THE DATE OF INITIAL ACCEPTANCE OF THE WORK BY THE OWNER AGAINST ALL DEFECTS IN MATERIALS AND WORKMANSHIP OF WHATEVER NATURE.
- 2. ALL CONSTRUCTION WILL BE INSPECTED BY THE OWNER'S REPRESENTATIVE. ALL WORK SHALL CONFORM TO THE REQUIREMENTS OF THE MUNICIPALITY AS WELL AS THE STANDARD SPECIFICATIONS.
- 3. ALL PUBLIC WATER MAINS AND SANITARY SEWER MAINS MUST BE ACCEPTED BY THE VILLAGE OF PALATINE FOR HAMILTON PARK AND PALATINE TRAIL PROJECTS AND VILLAGE OF HOFFMAN ESTATES FOR THE JUNIPER PARK PROJECT.
- 4. THE SEWER AND WATER CONTRACTOR SHALL BE REQUIRED TO BE LICENSED AND BONDED WITH THE VILLAGE OF PALATINE/VILLAGE OF HOFFMAN ESTATES BEFORE WORK IS STARTED.
- 5. CONTRACTOR SHALL NOTIFY THE VILLAGE OF PALATINE (847-202-6963)/VILLAGE OF HOFFMAN ESTATES (847-882-9100) AND THE PROJECT ENGINEER (847-478-9700) AT LEAST 72 HOURS PRIOR TO BEGINNING ANY WORK ON THIS PROJECT.
- 6. THE CONTRACTOR SHALL INDEMNIFY THE OWNER, ENGINEER, THE MUNICIPALITY AND THEIR AGENTS, FROM ALL LIABILITY INVOLVED IN CONSTRUCTION, INSTALLATION AND TESTING OF THE WORK ON THIS PROJECT.
- 7. THE CONTRACTOR MUST CARRY INSURANCE IN ACCORDANCE WITH THE STANDARD SPECIFICATIONS. ALL OFFICIALS, EMPLOYEES AND AGENTS OF GEWALT HAMILTON ASSOCIATES MUST BE LISTED AS ADDITIONAL INSURED.
- 8. ALL ELEVATIONS ARE ON NAVD 88 VERTICAL DATUM.
- 9. THE CONTRACTOR SHALL BE RESPONSIBLE FOR THE INSTALLATION AND MAINTENANCE OF ALL TRAFFIC CONTROL TO ADEQUATELY INFORM AND PROTECT THE PUBLIC OF ALL CONSTRUCTION OPERATIONS.
- 10. STOCKPILING MATERIAL WITHIN THE 100 YEAR FLOOD PLAIN AND OR THE FLOODWAY IS STRICTLY PROHIBITED
- 11. ALL PAVEMENT AND BUILDING SUBGRADE SHALL BE COMPACTED TO 95% MODIFIED PROCTOR DENSITY (ASTM D-1557). ALL SUBGRADE IN LAWN AREAS SHALL BE COMPACTED TO 90% MODIFIED PROCTOR DENSITY (ASTM D-1557). TOPSOIL AND SUBGRADE 6 BELOW TOPSOIL SHALL BE COMPACTED TO 80% STANDARD PROCTOR DENSITY (ASTM D-698).
- 12. PRIOR TO PLACEMENT OF FABRIC AND STONE, THE SUBGRADE SHALL BE PROOF—ROLLED IN THE PRESENCE OF THE ENGINEER. PROOF—ROLLING SHALL BE DONE USING A THREE AXLE DUMP TRUCK TOGETHER WITH LOAD WEIGHING AT LEAST TWENTY—FIVE (25) TONS. THE LOAD SHALL BE UNIFORMLY PLACED IN THE DUMP BODY. ALL DEFICIENCIES SHALL BE REPAIRED AND RE—PROOF—ROLLED UNTIL FOUND ACCEPTABLE TO THE ENGINEER.
- 13. CRUSHED CONCRETE IS NOT PERMITTED FOR USE ON THE PROJECT UNLESS PRIOR WRITTEN NOTICE IS GIVEN BY THE ENGINEER.
- 14. ALL STONE USED ON THE PROJECT SHALL BE CRUSHED UNLESS SPECIFICALLY NOTED OTHERWISE.
- 15. ALL CONCRETE SHALL HAVE A LIGHT BROOM FINISH APPLIED WITHIN 1 HOUR OF FINAL STRIKING.
- 16. ALL CONCRETE SHALL CONSIST OF PORTLAND CEMENT CONCRETE, 4" SLUMP, 6.1 BAG MIX AND AIR ENTRAINMENT OF NOT LESS THAN FIVE (5%) OR MORE THAN EIGHT (8%). CONCRETE SHALL BE A MINIMUM COMPRESSIVE STRENGTH (4000PSI) AT TWENTY EIGHT (28) DAYS. FLYASH MAY BE USED IN THE CONCRETE MIX.
- 17. ALL CONCRETE SHALL HAVE A WHITE, IDOT TYPE 3 CURING COMPOUND APPLIED TO THE SURFACE WITHIN 1 HOUR OF FINAL STRIKING AT THE MANUFACTURER RECOMMENDED APPLICATION RATE.
- 18. 3/4" THICK PRE-MOLDED FIBER EXPANSION JOINTS WITH 2, 3/4" x 18" PLAIN ROUND, STEEL DOWEL BARS SHALL BE INSTALLED IN ALL CURBS AT (45') FORTY-FIVE FOOT INTERVALS AND AT ALL P.C.'S, P.T.'S AND CURB RETURNS. ALTERNATE ENDS OF THE DOWEL BARS SHALL BE GREASED AND FITTED WITH METAL EXPANSION TUBES. ALL EXPANSION JOINTS MUST BE FREE OF CONCRETE FOR FULL DEPTH. CONTRACTION JOINTS SHALL BE TOOLED AT 15' INTERVALS.
- 19. UNLESS OTHERWISE NOTED ON THE PLANS WHENEVER NEW CONCRETE ABUTS EXISTING/ OR NEW CONCRETE SET A 1/2" THICK PRE-MOLDED FIBER EXPANSION JOINT AND DOWEL WITH SMOOTH 12" #4 BARS @ 24" O.C. THIS INCLUDES CONCRETE POURED ADJACENT TO EXISTING SIDEWALKS, CURBS AND BUILDING. THE DOWEL BARS SHOULD BE 4" INTO EXISTING CONCRETE WITH 8" EXTENDING INTO NEW CONCRETE.
- 20. ALL DOWEL BARS AND TIE BARS SHALL BE EPOXY COATED UNLESS NOTED OTHERWISE.
- 21. SPREAD SCREENED TOPSOIL ON ALL DISTURBED AREAS AND PROPOSED GREEN AREAS. TOPSOIL SHALL COMPLY WITH REQUIREMENTS OF ARTICLE 1081.05.
- 22. ALL SIGNAGE SHALL BE INSTALLED IN ACCORDANCE WITH THE MOST RECENT VERSION OF THE MANUAL ON UNIFORM TRAFFIC CONTROL DEVICES AND ILLINOIS SUPPLEMENT OR ILLINOIS DEPARTMENT OF TRANSPORTATION DETAILS.

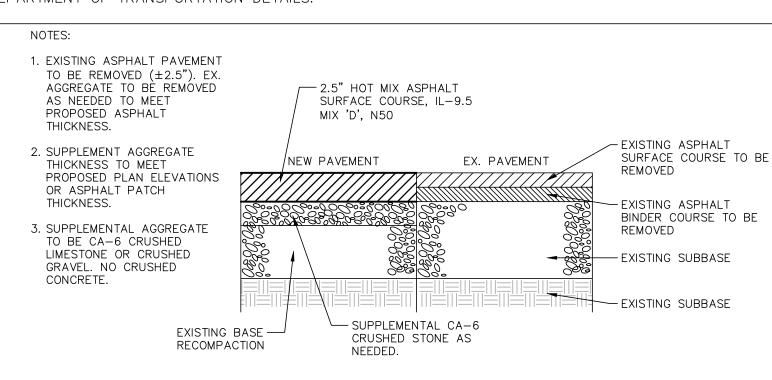


2.5" PAVEMENT PATCH DETAIL

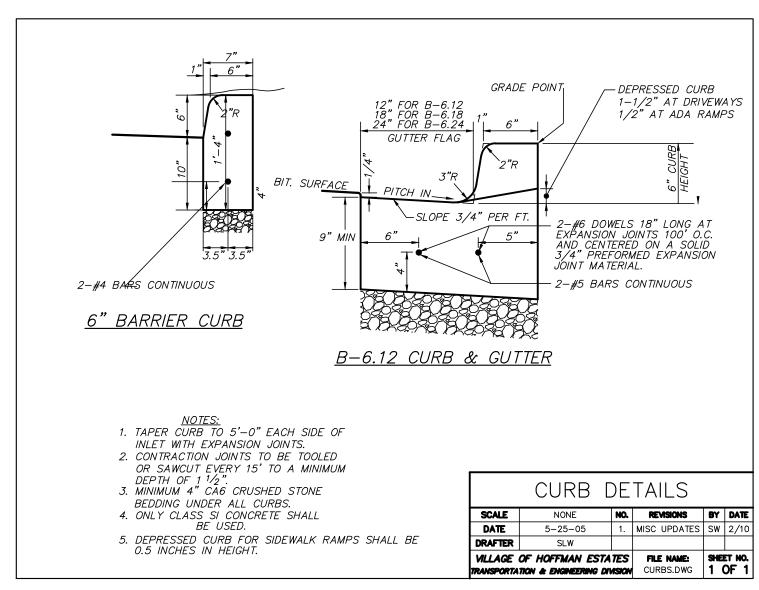


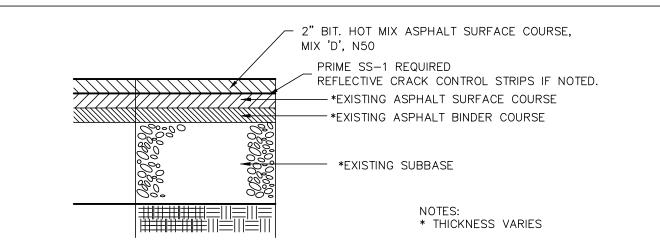


#### PAVEMENT OVERLAY DETAIL

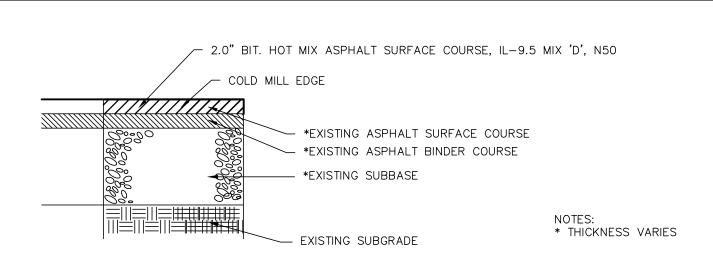


#### 2.0" PAVEMENT PATCH DETAIL

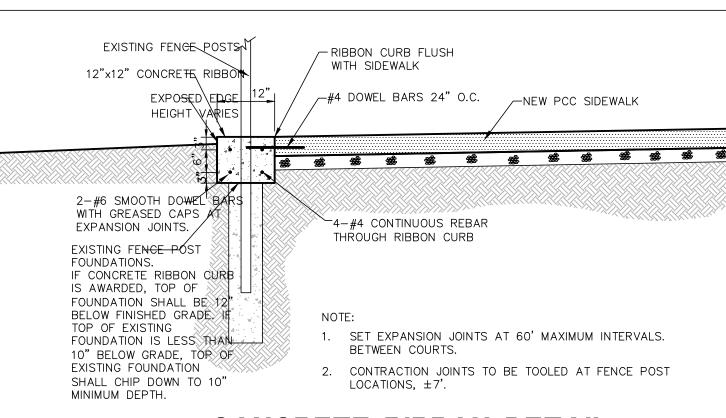


## CONCRETE RIBBON DETAIL ALTERNATE #2

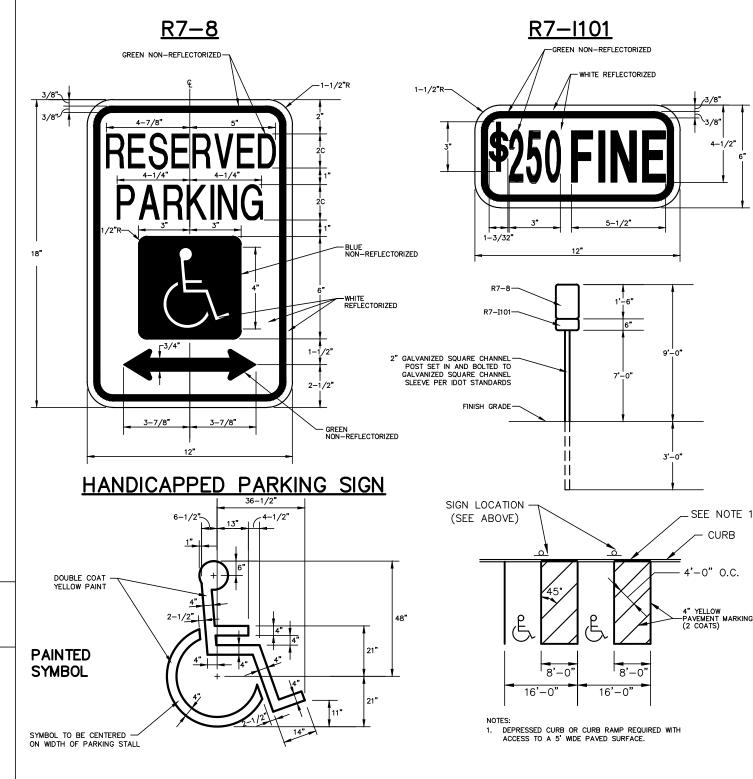

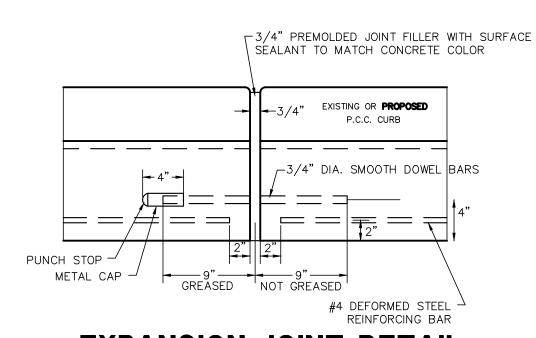

#### **EXPANSION JOINT DETAIL**

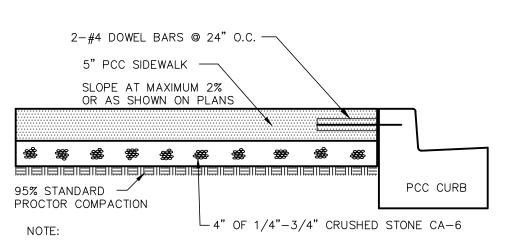

- SET 3/4" EXPANSION JOINTS AT POINTS ABUTTING CURB OR PAVEMENT AND AT 60' MAX. INTERVALS.
- 2. CONTROL JOINTS SHALL BE 1/8" TO 1/4" WIDE AND 1/4 OF THE SIDEWALK THICKNESS DEEP. THE EDGE OF THE CONTROL JOINTS SHALL BE GIVEN A 1/4" RADIUS.
- 3. SIDEWALK WIDTH AS SHOWN ON PLANS

**PCC SIDEWALK DETAIL** 

### GEWALT HAMILTON ASSOCIATES, INC. 625 Forest Edge Drive - Vernon Hills, IL, 60061

TEL 847.478.9700 FAX 847.478.9701

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### **GENERAL NOTES AND DETAILS**

PROPOSED SITE IMPROVEMENTS
PALATINE PARK DISTRICT
PALATINE. ILLINOIS

				FILE: 5241.210 - DT1 Palat	tine Trail & Juniper Park.dwg	SHE
				<b>DRAWN BY:</b> EJS <b>DATE:</b> 07-05-18	<b>GHA PROJECT #</b> 5241.300	
,	DATE	REVISION		<b>CHECKED BY:</b> TAR <b>DATE:</b> 07-05-18		OF

SHEET NUMBER:

11

OF 11 SHEETS

11	40603335	Hot-Mix Asphalt Surface Course, Mix 'D', N50	TN	100	270.0	27,000
12	44000157	Hot-Mix Asphalt Surface Removal, 2"	SY	4 ~	1,000.0	4,000-
13	44201690	Class D Patches, Type I, 4 Inch	SY	35 -	310.0	10,850
14	67100100	Mobilization	LS	3,000-	1.0	3,000-
15	X7010216	Traffic Control & Protection, (Special)	LS	1.126	1.0	1.126
16	-	Temporary Portable Restroom Facility	CAL MO	'aso-	2.0	500-
Item 5 Total – Revised 7/16/18						
51	xty Nin	e Thousand Nine Hundred	and 00/10	0		Dollars

ADA Related Costs

Item 6: JUNIPER PARK

Item#	Pay Item	Description	Unit	Unit Price	Site Civil Quantitie	Cost	
1	20101000	Temporary Fence	FT	3 ~	200.0	400 <sup>~</sup>	
2	20101100	Tree Trunk Protection	EA	125	2.0	250-	-
3	20201200	Removal and Disposal of Unsuitable Material	CY	25 -	50.0	1,250-	•
4	21101600	Topsoil Furnish and Place, Variable Depth	SY	8 -	350.0	2,800-	
5	25000110	Seeding, Class 1A	AC	3,100-	0.10	310	
6	25000400	Nitrogen Fertilizer Nutrient	LBS	4.25	9.0	38.25	
7	25000600	Potassium Fertilizer Nutrient	LBS	4.25	9.0	38,25	
8	25100127	Mulch, Method 3A	AC	5,200-	0.1	520-	
9	25200200	Supplemental Watering	UN	57.75	10.0	577.50	
10	28000400	Perimeter Erosion Barrier	FT	3.50	200.0	700-	
11	28000510	Inlet filters	EA	200~	1.0	200-	
12	30300001	Aggregate Subgrade Improvement	CY	30~	50.0	1,500	
13	35101582	Aggregate Base Course, Type B 2"	SY	3~	460.0	1,380-	7
14	40600290	Bituminous Material (Tack Coat)	LBS	,01	475.0	4.75	
15	40600982	Hot-Mix Asphalt Surface Removal - Butt Joint	SY	5 ~	220.0	1,100	
16	40603335	Hot-Mix Asphalt Surface Course, Mix 'D', N50	TN	100-	180.0	18,000	\$2,423
17	42400200	Portland Cement Concrete Sidewalk, 5"	SF	7.25	4,100.0	29,725	-\$13,050
18	42400800	Detectable Warnings	SF	37,25	16.0	596	- φ το, σοσ
19	44000500	Combination Curb and Gutter Removal	FT	10 -	15.0	150	_
20	44000600	Sidewalk Removal	SF	3 -	80.0	240-	_
21	44201690	Class D Patches, Type I, 4 Inch	SY	35 ~	100.0	3,500	_
22	60300105	Frames and Grates To Be Adjusted	EA	6000-	1.0	1,000	_
23	60603800	Combination Concrete Curb & Gutter, Type B-6.12	FT	55 ~	15.0	825	
24	67100100	Mobilization	LS	7,500-	1.0	7,500	\$2,000
25	72000100	Sign Panel - Type 1	SF	25 ~	4.0	100~	
26	72400100	Remove Sign Panel Assembly - Type A	EA	75 -	2.0	150-	_
27	72900100	Metal Post - Type A	FT	25 -	30.0	750-	
28	78001100	Paint Pavement Markings - Letters & Symbols	SF	10-	7.0	70-	
29	78001110	Paint Pavement Markings - 4"	FT	.75	680.0	510-	_
30	X0300019	Remove and Reinstall Parking Blocks, (Special)	EA	35~	32.0	1,120-	_
31	X0301430	Precast Concrete Parking Block, (Special)	EA	100-	1.0	100-	_
32	X7010216	Traffic Control & Protection, (Special)	LS	2,582.75	1.0	2,582.75	
33	-	Earth Excavation - Juniper Base Bid, (Special)	LS	7,500	1.0	7,500-	
34	-	Pulverization, 5" - Stockpile Onsite, (Special)	SY	7,50	475.0	3,562,50	-

35		Damage and Da Install Balland (Consist)				
	-	Remove and Re-Install Bollard, (Special)	EA	1,000	1.0	1,000
36		Remove and Re-Install Furniture, (Special)	EA	250-	5.0	1,250
37	*	Temporary Concrete Washout	EA	1,000	1.0	1,000
38		Temporary Portable Restroom Facility	CAL	200	4.0	800
39	•	Stabilized Construction Entrance	SY	10-	160.0	1,600-
Item 6 Total - 7/16/18						94,900.00
Nine	ety Fo	our Thousand Nine Hundred and	00/	100		Dollars

#### JUNIPER PARK - Alternate #2

ltem#	Pay Item	Description	Unit	Unit Price	Site Ci	
1	20201200	Removal and Disposal of Unsuitable Material	CV		Quant	
		Pri No. 16: 16: 15: 5	CY	25	40.0	1,000
2	21101600	Topsoil Furnish and Place, Variable Depth	SY	10 -	210.0	2,100
3	25000110	Seeding, Class 1A	AC	3,100	0.10	310~
4	25000400	Nitrogen Fertilizer Nutrient	LBS	4,25	9.0	38,25
5	25000600	Potassium Fertilizer Nutrient	LBS	4.25	9.0	38,25
6	25100127	Mulch, Method 3A	AC	5,200-	0.1	520-
7	28000400	Perimeter Erosion Barrier	FT	3,50	130.0	455
8	28000510	Inlet filter	EA	175-	1.0	175
9	30300001	Aggregate Subgrade Improvement	CY	30-	40.0	1,200
10	35101600	Aggregate Base Course, Type B 4"	SY	5-	105.0	525"
11	42400200	Portland Cement Concrete Sidewalk, 5"	SF	7,75	920.0	7,130
12	42400800	Detectable Warnings	SF	40-	10.0	400-
13	44000100	Pavement Removal	SY	25	10.0	250-
14	44000500	Combination Curb and Gutter Removal	FT	10~	22.0	220-
15	60600605	Concrete Curb, Type B	FT	56-	18.0	1,008-
16	60603800	Combination Concrete Curb & Gutter, Type B-6.12	FT	51-	30.0	1,530~
17	-	Bollard & Foundation Removal	EA	150-	1.0	150~
18	-	Earth Excavation - Juniper Alternate 1, (Special)	LS	2,960.50	1.0	2,950.50
Alternate 2 Total – Revised 7/16/18 20,000.00						
Twenty Thousand and 00/100						

#### JUNIPER PARK - Alternate #3

item#	Pay Item	Description	Unit	Unit Price		Civil Cost
1		Concrete Ribbon Curb, Special	FT	35~	120.0	4,200
2		Remove And Replace Backstop Chain Link, Special	EA	15,000	1.0	15,000















